


PROJECT DESIGN BY:

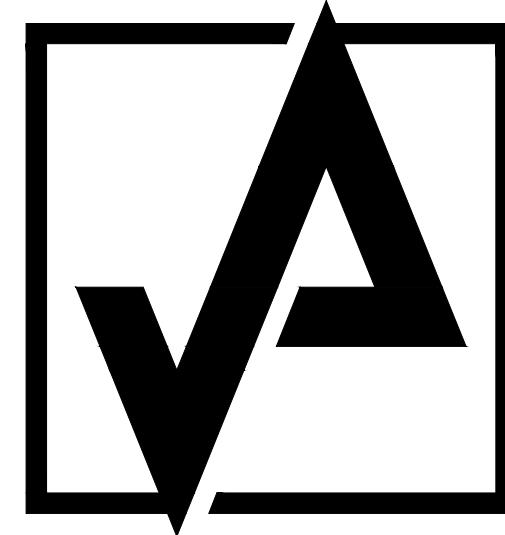

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OWNER:

RHODE ISLAND DEPARTMENT OF ADMINISTRATION  
DELSIE LONGOLUCCO  
CELL: (401) 374-5171  
EMAIL: delsie.longolucco@doa.ri.gov

**S H E P A R D   B L D G  
4 T H   F L O O R   R E N O V A T I O N  
8 0   W A S H I N G T O N   S T R E E T  
P R O V I D E N C E  
R H O D E   I S L A N D  
P R O V I D E N C E   C O U N T Y**

**D E C E M B E R   1 9 ,   2 0 2 5  
R E V   # 1   -   J A N U A R Y   0 2 , 2 0 2 6  
R E V   # 2   -   J A N U A R Y   2 1 , 2 0 2 6  
R E V   # 3   -   J A N U A R Y   2 7 , 2 0 2 6  
R E V   # 4   -   F E B R U A R Y   0 2 , 2 0 2 6  
F O R   C O N S T R U C T I O N**

**INDEX OF DRAWINGS**

ISSUE DATE	DWG NO	DESCRIPTION	REV 1	REV 2	REV 3	REV 4
12/19/25	CS0.1	CODE INFO, EGRESS & OCCUPANCY DIAGRAMS	X	X		X
12/19/25	D1.1	DEMOLITION FLOOR PLAN		X	X	
12/19/25	A1.1	FLOOR PLAN, DOOR & STOREFRONT SCHEDULE & DETAILS	X	X		X
12/19/25	A1.2	FLOOR FINISH PLAN & DETAILS		X		
12/19/25	A1.3	REFLECTED CEILING PLAN, SCHEDULE & DETAILS	X	X		
12/19/25	A1.4	FURNITURE PLAN & ADA COMPLIANCE	X	X	X	X
01/02/26	E0.1	ELECTRICAL COVER SHEET	ADDED	X	X	X
01/02/26	E1.1	ELECTRICAL POWER, FIRE ALARM, & SYSTEMS PLAN - DEMOLITION	ADDED	X	X	X
01/02/26	E1.2	ELECTRICAL POWER, FIRE ALARM, & SYSTEMS PLAN - NEW WORK	ADDED	X	X	X
01/02/26	E2.1	ELECTRICAL LIGHTING PLAN - DEMOLITION	ADDED	X	X	
01/02/26	E2.2	ELECTRICAL LIGHTING PLAN - NEW WORK	ADDED	X	X	
01/02/26	E3.1	ELECTRICAL SCHEDULES AND DETAILS	ADDED	X	X	
01/02/26	E3.2	ELEC DAYLIGHTING ZONING AND LIGHTING CONTROLS SEQUENCES	ADDED	X	X	X



## CODE ANALYSIS - EXISTING COMMERCIAL BUILDING REMODEL

PROJECT SCOPE:  
BUILDING STATUS:  
GOVERNING CODE:  
BASE CODE:  
OCCUPANCY:  
NUMBER OF STORIES:  
OCCUPANCY LOAD:  
SPRINKLER SYSTEM:  
CONSTRUCTION TYPE:  
ALTERATION LEVEL:  
PRIMARY EGRESS STANDARD:  
SECONDARY EGRESS STANDARD:  
MEANS OF EGRESS - CODE CRITERIA:

INTERIOR REMODEL OF APPROXIMATELY 1/3 STORY (15,215 SF)  
EXISTING  
RISRC-1 - RHODE ISLAND STATE REHABILITATION BUILDING AND FIRE CODE FOR EXISTING BUILDINGS AND STRUCTURES  
2018 INTERNATIONAL EXISTING BUILDING CODE (IEBC), AS AMENDED  
BUSINESS (GROUP B)  
6  
102 OCCUPANTS (BASED ON OCCUPANT LOAD FACTOR OF 1.00 FOR BUSINESS REQUIRED BY NFPA 101 AND IBC 2018)  
FULLY SPRINKLERED THROUGHOUT (NFPA 13)  
EXISTING (NO CHANGE PROPOSED)  
LEVEL 2 ALTERATION  
RISRC-1 WITH REFERENCED IBC AND NFPA 101 PROVISIONS  
RILSC (NFPA 101 - 2018 EDITION)


### MEANS OF EGRESS - CODE CRITERIA:

ITEM	REQUIREMENT	CODE REFERENCE
MAX COMMON PATH OF TRAVEL	100 FT	IBC TABLE 1006.2.1 / NFPA 101 §7.6.1.2
MAX TRAVEL DISTANCE	300 FT	IBC TABLE 1017.2 / NFPA 101 §7.6.1.1
NUMBER OF EXITS	MIN. 2 (WHERE OL > 44)	IBC §1006.2.2
EXIT SEPARATION	1/3 DIAGONAL (SPRINKLERED)	IBC §1007.1.1 / NFPA 101 §7.5.1.3
EXIT ACCESS WIDTH	PER OCCUPANT LOAD	IBC §1025
STAIR ENCLOSURES	EXISTING, NO REDUCTION	IBC §1028 / NFPA 101 CH. 7


GOVERNING PRINCIPLE: MOST RESTRICTIVE REQUIREMENT APPLIES

### EGRESS COMPLIANCE NOTES:


- MEANS OF EGRESS:  
THIS PROJECT IS AN ALTERATION TO AN EXISTING BUILDING AND IS GOVERNED BY THE RHODE ISLAND STATE REHABILITATION BUILDING AND FIRE CODE FOR EXISTING BUILDINGS AND STRUCTURES (RISRC-1, AS AMENDED) AND THE RHODE ISLAND LIFE SAFETY CODE (NFPA 101, 2018 EDITION).
- TRAVEL DISTANCE/COMMON PATH:  
IN ACCORDANCE WITH IBC TABLES 1006.2.1 AND 1017.2, AND NFPA 101 SECTIONS 7.6.1.1 AND 7.6.1.2, EGRESS TRAVEL DISTANCES: MAXIMUM COMMON PATH OF EGRESS TRAVEL DOES NOT EXCEED 100 FEET. MAXIMUM EXIT ACCESS TRAVEL DISTANCE: DOES NOT EXCEED 300 FEET, MEASURED FROM THE MOST REMOTE POINT TO THE ENTRANCE OF AN EXIT.
- EXIT SEPARATION:  
REQUIRED EXIT SEPARATION IS PROVIDED AT A MINIMUM OF ONE-THIRD (1/3) THE MAXIMUM DIAGONAL DISTANCE OF THE AREA SERVED, AS PERMITTED FOR FULLY SPRINKLERED BUILDINGS, IN ACCORDANCE WITH IBC SECTION 1007.1.1 AND NFPA 101 SECTION 7.5.1.3.
- EXISTING CONDITIONS:  
EXISTING EXIT STAIRS, ENCLOSURES, AND DISCHARGE COMPONENTS ARE MAINTAINED AND ARE NOT REDUCED OR MADE NONCOMPLIANT BY THIS WORK.

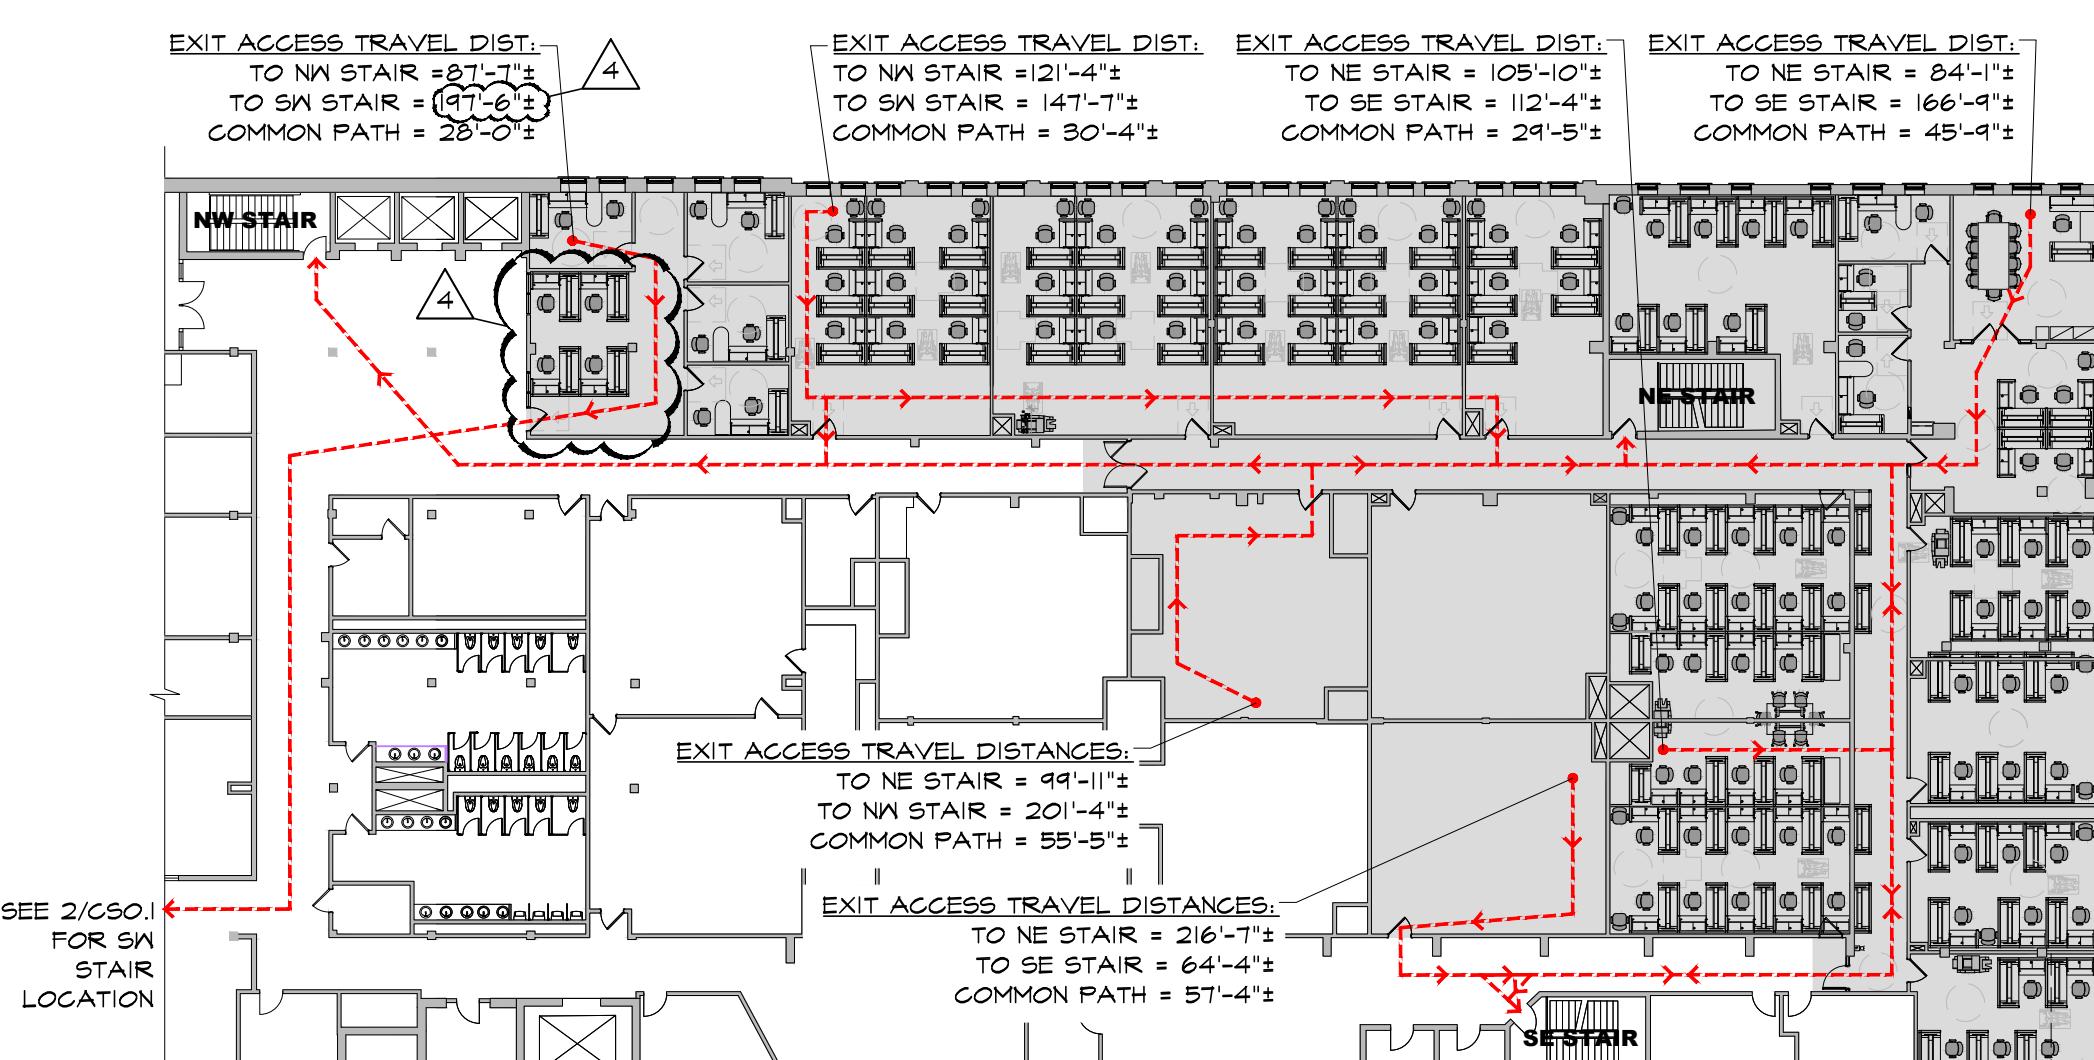


4 EGRESS DIAGRAM  
NOT TO SCALE

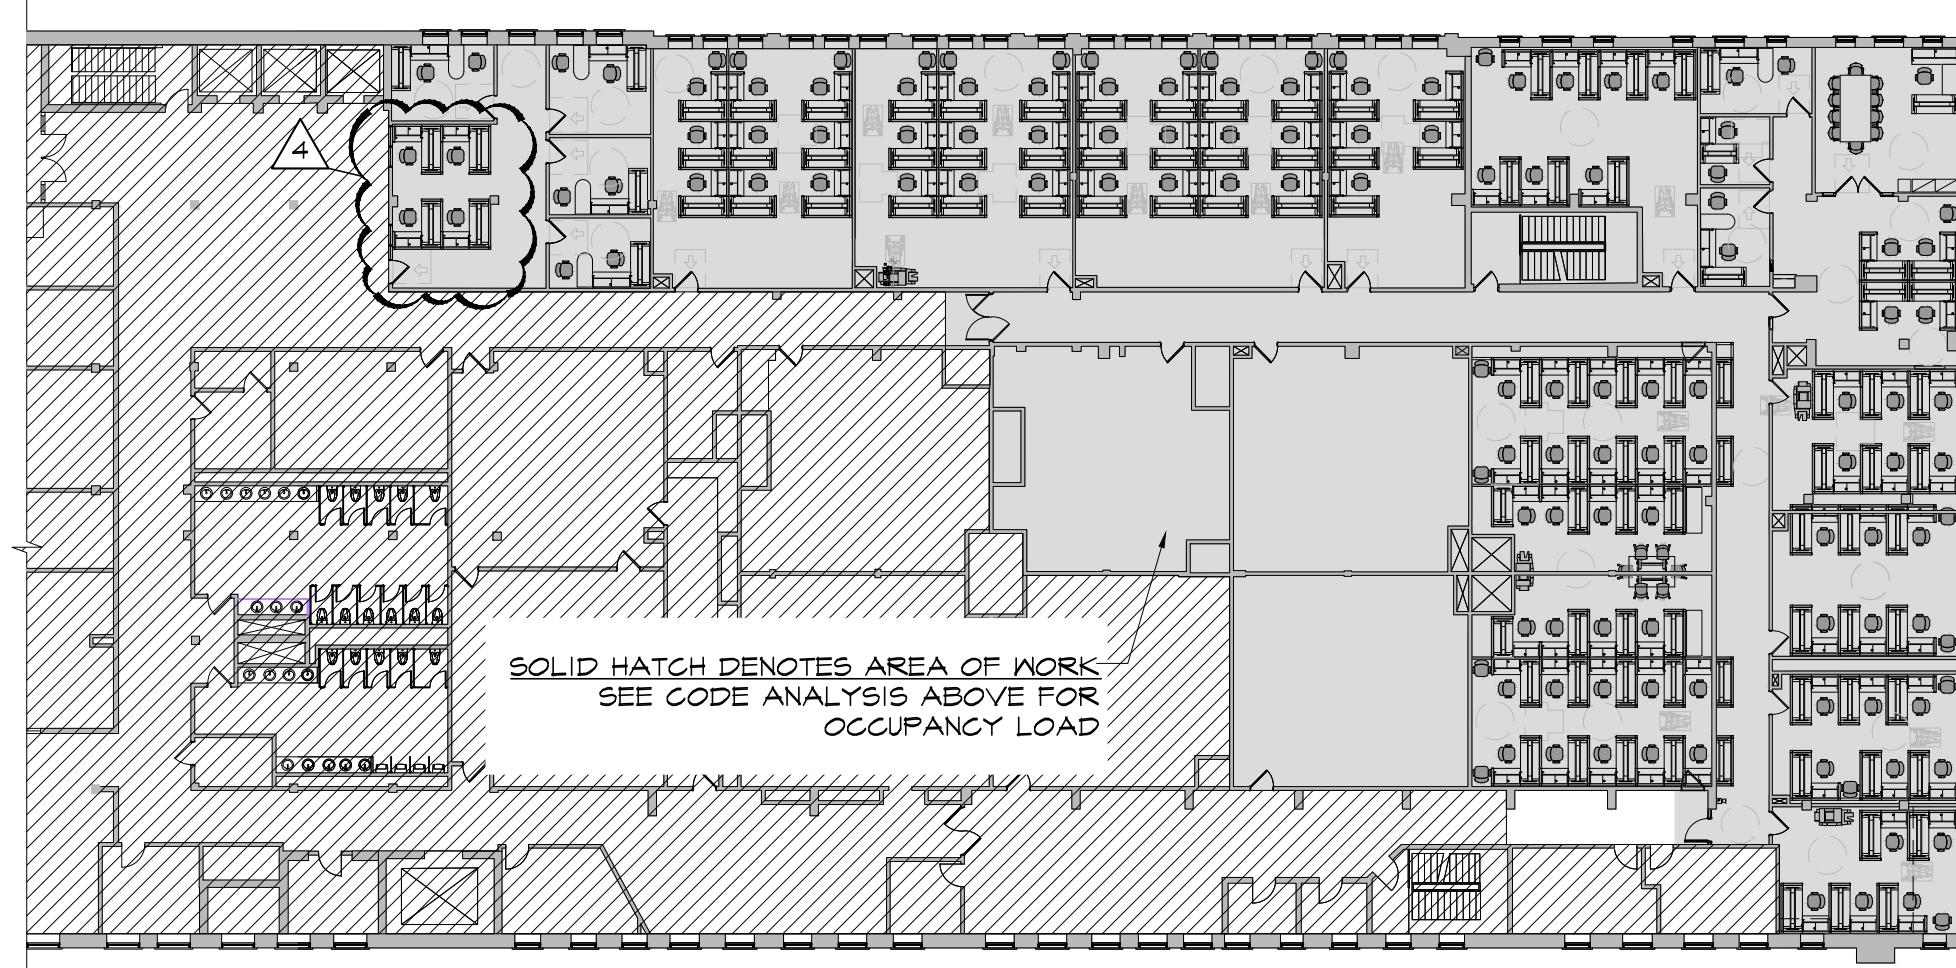

3 OCCUPANCY DIAGRAM  
NOT TO SCALE

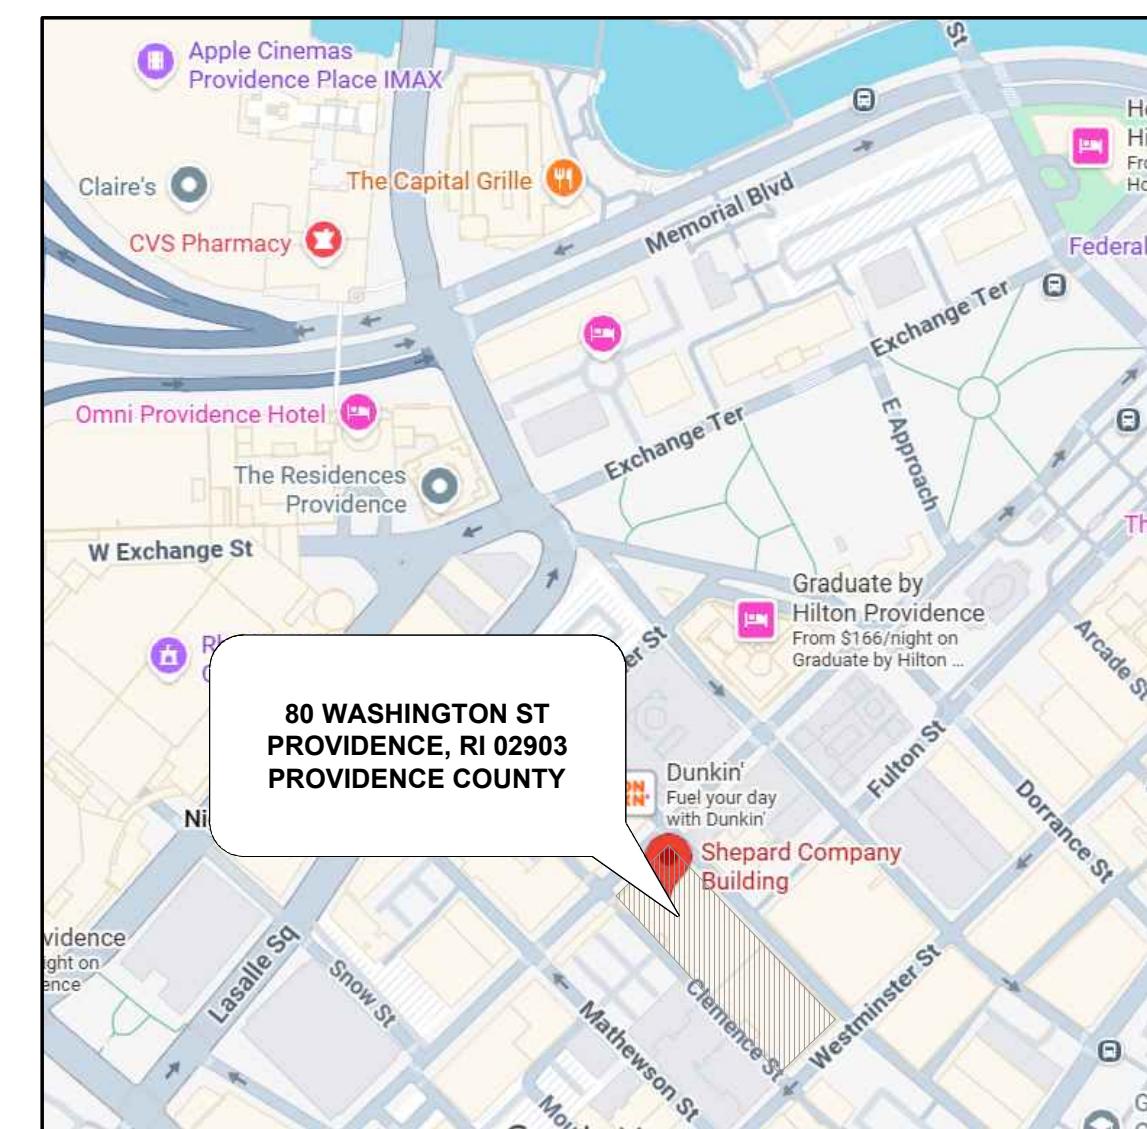

1 LOCUS MAP  
SCALE: NOT TO SCALE

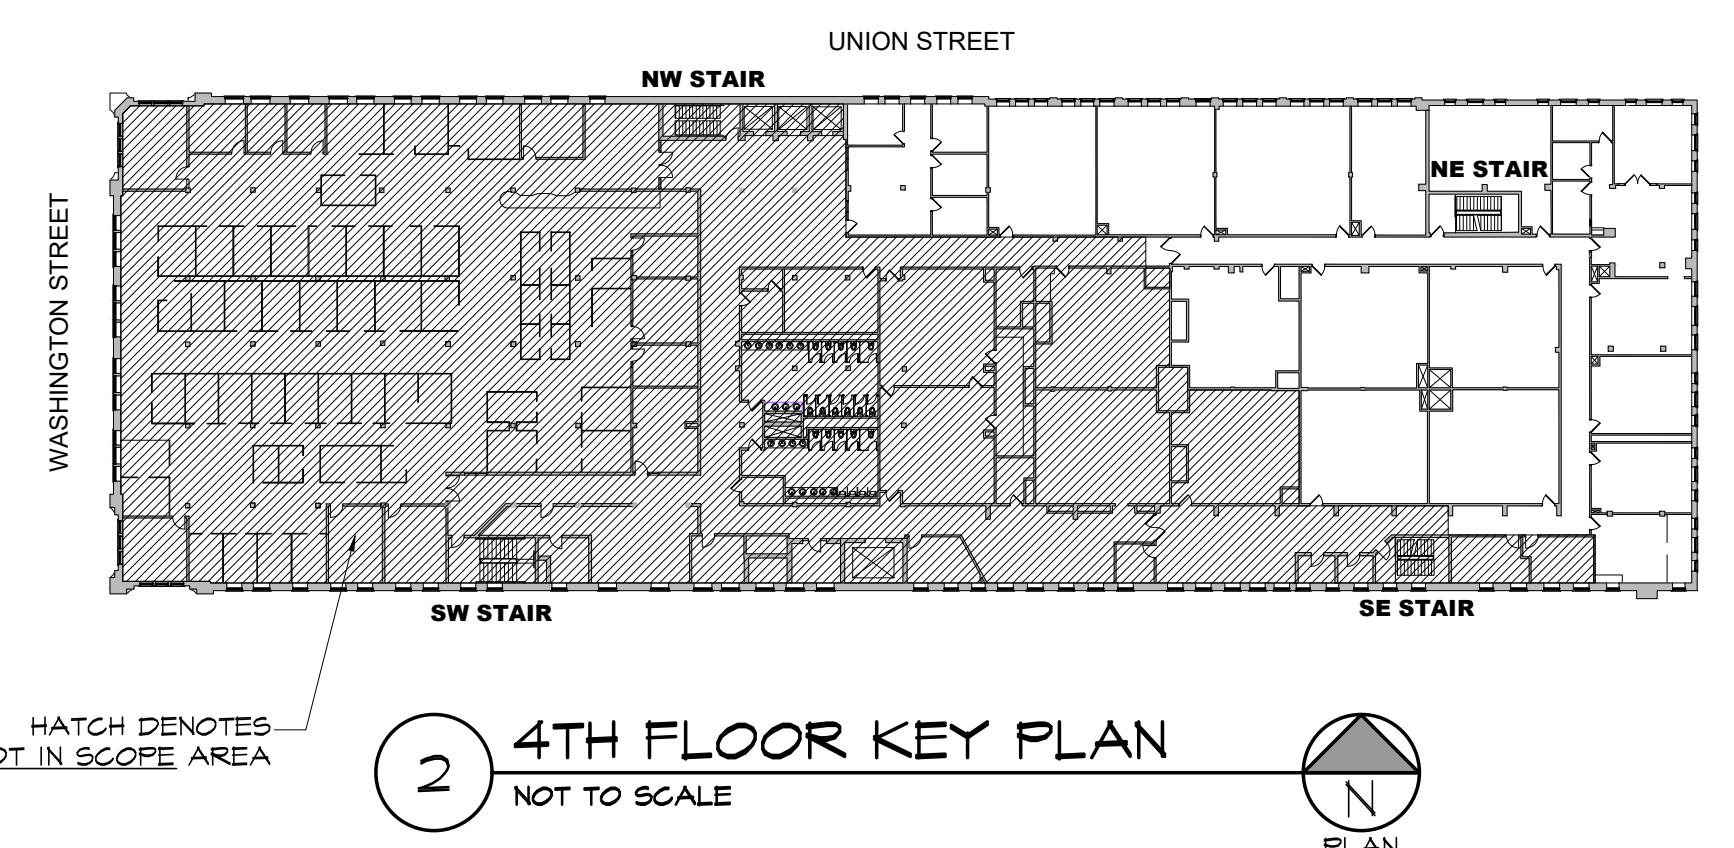

2 4TH FLOOR KEY PLAN  
NOT TO SCALE

## CONTROLLED CONSTRUCTION REQ'D INSPECTIONS

IF THIS OFFICE IS CONTRACTED TO DO CONTROLLED CONSTRUCTION, THE FOLLOWING CONSTRUCTION PROGRESS INSPECTIONS MUST BE PERFORMED BY THE ARCHITECT & ENGINEERS PRIOR TO ISSUING FINAL AFFIDAVITS FOR CERTIFICATE OF OCCUPANCY. GC MUST PROVIDE A SCHEDULE AT THE START OF THE PROJECT & GIVE 48 HOURS NOTICE PRIOR TO REQUIRED INSPECTION.

INSPECTION #	- TYPE OF INSPECTION	RESPONSIBLE PARTY
INSPECTION #1	- INSPECT INTERIOR WALL FRAMING AND ELECTRICAL ROUGH-IN PRIOR TO INSULATING	ARCHITECT
INSPECTION #2	- FINAL INSPECTION WITH ALL LIFE SAFETY COMPONENTS INSTALLED	ARCHITECT

## CODES, RULES, REGULATIONS


FEDERAL, STATE AND MUNICIPAL LAWS  
PROVIDENCE, RHODE ISLAND RULES AND/OR REGULATIONS  
RHODE ISLAND REHABILITATION BUILDING AND FIRE FOR EXISTING STRUCTURES - BUILDING REGULATION RISRC-1 (REF: 2018 INTERNATIONAL BUILDING CODE)  
ALTERATION LEVEL: 2  
RI STATE BUILDING CODE - PLUMBING CODE REGULATION SBC-3 (REF: 2018 INTERNATIONAL PLUMBING CODE)  
RI STATE BUILDING CODE - ELECTRICAL CODE REGULATION SBC-5 (REF: 2020 NATIONAL ELECTRICAL CODE)  
RI STATE BUILDING CODE - MECHANICAL CODE REGULATION SBC-4 (REF: 2018 INTERNATIONAL MECHANICAL CODE)  
RI FIRE SAFETY CODE (REF: 2019 NFPA 1 UNIFORM FIRE CODE & 2018 NFPA 101 LIFE SAFETY CODE)  
ANSI 1171-1-2009 W  
RI STATE BUILDING CODE  
ANY PREVAILING RULES, REGULATIONS PERTAINING TO ADEQUATE PROTECTION AND/OR GUARDING OF ANY MOVING PARTS OR OTHERWISE HAZARDOUS LOCATIONS.

ALL CONTRACTORS AND SUBCONTRACTORS SHALL COMPLY WITH REQUIREMENTS OF THE OCCUPATIONAL SAFETY AND HEALTH ACT OF 1970 OR REVISIONS THERETO, WHICH ARE APPLICABLE DURING THE TERM OF THIS CONTRACT AND HOLD THE OWNER AND/OR HIS/HER AGENTS HARMLESS FROM ANY CLAIM OR LOSS THAT MAY RESULT FROM VIOLATIONS OF OR CLAIMS UNDER THIS ACT.

THE PROPOSED RENOVATIONS TO A PORTION OF THE 4TH FLOOR DO NOT ALTER OR REDUCE THE BUILDING'S COMPLIANCE WITH ANY APPLICABLE BUILDING CODE, THE BUILDING'S BASIC CHARACTERISTICS, INCLUDING OVERALL AREA AND HEIGHT, CONSTRUCTION TYPE, OCCUPANCY CLASSIFICATION AND LOAD, MEANS OF EGRESS, AND FIRE SAFETY, ARE NOT BEING MODIFIED.

## ABBREVIATIONS INDEX

&	AND	MO	MASONRY OPENING
@	AT	MTD	MONTE
A/C	AIR CONDITIONING	NIC	NOT IN CONTRACT
AF	ABOVE FLOOR	NO	NUMBER
ALUM	ALUMINUM	NOM	NOMINAL
ALT	ALTERNATIVE	NTS	NOT TO SCALE
APPROX	APPROXIMATE	OA	OVERALL
BD	BOARD	OC	ON CENTER
BG	BELLOW GRADE	OCH	ON CENTER HORIZONTALLY
BLDG	BUILDING	OCV	ON CENTER VERTICALLY
BM	BEAM	OD	OUTER DIAMETER
BSMT	BASEMENT	OPNG	OPENING
BWTN	BETWEEN	OPT	OPTIONAL
BOT	BOTTOM	PL	PLATE
C/L	CENTER LINE	PLAM	PLASTIC LAMINATE
CT	CERAMIC TILE	PLUMB	PLUMBING
CLG	CEILING	PLYWD	PLYWOOD
CLO	CLOSET	PR	PAIR
CM	CONSTRUCTION MGR	PROP	PROPERTY
CMU	CONCRETE MASONRY UNIT	PSF	PER SQUARE FOOT
COL	COLUMN	PSI	PER SQUARE INCH
CONC	CONCRETE	PT	PRESSURE TREATED
CONT	CONTINUOUS	PTD	PAINTED
CONSTR	CONSTRUCTION	PVC	POLYVINYL CHLORIDE
DEPT	DEPARTMENT	QT	QUARRY TILE
DTL	DETAIL	RAD	QUANTITY
DIA/Ø	DIAmeter	REF	RADiATOR
DIM	DIMENSION	REFIN	REINFORCING
DISP	DISPENSER	REV	REVISION
DN	DOWN	REQ'D	REQUIRED
DR	DOOR	REQTS	REQUIREMENTS
DS	DOWNSPOUT	RES	RESILIENT
DWG	DRAWING	RM	ROOM
EA	EACH	RO	ROUGH OPENING
EL	ELEVATION	SCHED	SCHEDULE
ELEC	ELECTRICAL	SEC	SECTION
EQ	EQUAL	SF	SQUARE FOOT
EQUIP	EQUIPMENT	SHT	SHEET
ETR	EXISTING TO REMAIN	SIM	SIMILAR
EXIST	EXISTING	SPEC	SPECIFICATION
EXT	EXTERIOR	SQ	SQUARE
FCB	FIBER CEMENT BOARD	SS	STAINLESS STEEL
FD	FLOOR DRAIN	STD	STANDARD
FIN	FINISH	STL	STEEL
FL	FLOOR	STRUCT	STRUCTURAL
FO	FACE	SUSP	SUSPENDED
FR	FIRE RETARDANT	TBD	TO BE DETERMINED
FT	FOOT	TEL	TELEPHONE
FTB	FLOOR TILE BASE	THK	THICK
FURN	FURNITURE	THRU	THROUGH
GA	GAUGE	TOP	TOP OF PLATE
GALV	GALVANIZED	TOPS	TOP OF STEEL
GYP BD	GYPSUM BOARD	TOPSL	TOP OF SLAB
HDWD	hardware	TRT	TREATED
HDR	HEADER	TYP	TYPICAL
HM	HOLLOW METAL	UNO	UNLESS NOTED OTHERWISE
HORIZ	HORIZONTAL	VB	VINYL BASE
HGT	HEIGHT	VCT	VINYL COMPOSITE TILE
ID	INSIDE DIAMETER	VERT	VERTICAL
INSUL	INSULATION	VIF	VERIFY IN FIELD
INT	INTERIOR	VWC	VINYL WALL COVERING
JT	JOINT	w/	WITH
KIT	KITCHEN	WC	WATER CLOSET
LAM	LAMINATE	WFS	WATER FILTRATION SYSTEM
LAV	LAVATORY	WP	WITHOUT
LT	LIGHT	WT	WATERPROOFING
MAS	MASONRY	WWF	WEIGHT
MAX	MAXIMUM		WELDED WIRE FABRIC
MECH	MECHANICAL		
MTL	METAL		
MANUF	MANUFACTURER		
MIN	MINIMUM		
MISC	MISCELLANEOUS		

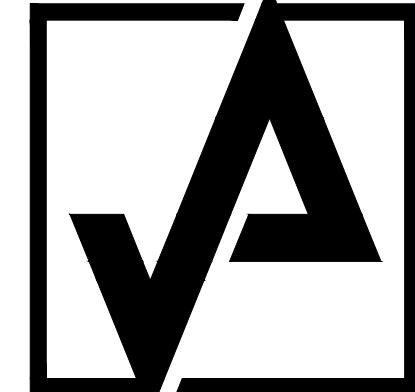

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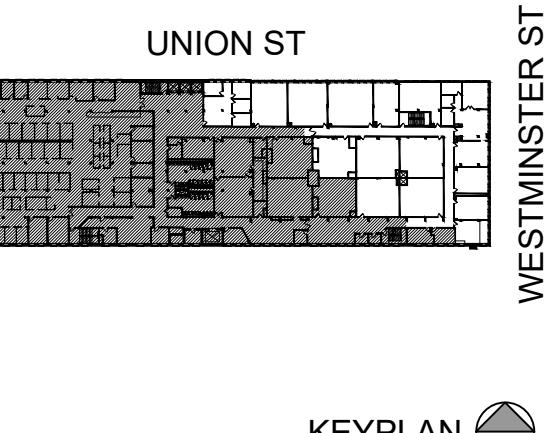
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## FOR CONSTRUCTION

REVISIONS:



NUMBER	REMARKS	DATE
1	BCC COMMENTS	01/02/2026
2	OWNER + BCC COMMENTS	01/21/2026
4	OWNER COMMENTS	02/02/2026



## GRAPHIC SYMBOLS

	INTERIOR ELEVATION NUMBER/SHEET		FRAME / WINDOW TYPE
	SECTION OR DETAIL KEY NUMBER/SHEET		EQUIPMENT TAG
	DETAIL KEY		PARTITION TYPE
	ROOM NAME ROOM NUMBER		ETR CONSTRUCTION
	FINISH NUMBER		EXIST CONSTRUCTION TO BE REMOVED
	KEYED PLAN NOTE		NEW PARTITION
	DOOR TYPE		AREA NOT IN SCOPE

PROJECT TITLE:  
SHEPARD BUILDING  
4TH FLOOR RENOVATION

DRAWING TITLE:  
80 WASHINGTON STREET  
PROVIDENCE, RI 02903  
PROVIDENCE COUNTY

DATE: JAN XX, 2026 PROJ NO: 25175  
DRAWN BY: AL CHECKED BY: DH

**GENERAL DEMOLITION NOTES****PROTECTION**

- 1) ALL RULES & REGULATIONS GOVERNING THE RESPECTIVE UTILITIES SHALL BE OBSERVED IN EXECUTING ALL WORK UNDER THIS SECTION. ALL WORK SHALL BE EXECUTED IN SUCH A MANNER AS TO PREVENT ANY DAMAGE TO THE EXISTING BUILDING, SERVICE UTILITY LINES & STRUCTURES.
- 2) THE CONTRACTOR SHALL ASSUME FULL RESPONSIBILITY FOR DAMAGES TO THE EXISTING BUILDING AS WELL AS ADJOINING PRIVATE SPACES & PROPERTY CAUSED BY HIS SUBCONTRACTOR'S EQUIPMENT & PERSONNEL.
- 3) PERFORM THE WORK IN SUCH A MANNER AS TO CAUSE NO INTERFERENCE w/ ACCESS BY THIS SUBCONTRACTOR OR OTHER CONTRACTORS TO ALL PORTIONS OF THE BUILDING AS NECESSARY FOR THE NORMAL CONDUCT OF THEIR WORK.
- 4) THE CONTRACTOR SHALL NOT COMMENCE WORK UNTIL ITEMS SCHEDULED TO REMAIN HAVE BEEN ADEQUATELY PROTECTED. TAKE ALL POSSIBLE PRECAUTIONS TO AVOID DAMAGING THOSE ITEMS WHICH HAVE BEEN SPECIFIED BY THE OWNER TO BE SALVAGED AND/OR STOCKPILED.

**PREPARATION**

- 1) NOTIFY ALL CORPORATIONS, COMPANIES, INDIVIDUALS OR LOCAL AUTHORITIES OWNING OR HAVING JURISDICTION OVER UTILITIES RUNNING TO, THROUGH OR ACROSS AREAS TO BE DISTURBED BY DEMOLITION OPERATIONS.
- 2) HAVE ALL UTILITY SERVICES NOT OTHERWISE DESIGNATED TO BE DISCONNECTED BY THE CONTRACTOR, DISCONNECTED @ SERVICE MAINS BY THE GOVERNING UTILITY INVOLVED, UNLESS OTHERWISE SHOWN ON THE DRAWINGS OR DIRECTED BY THE ARCHITECT.
- 3) DEMOLISH DESIGNATED FEATURES ABOVE & BELOW FLOOR LEVELS, WITHIN THE CONTRACT LIMIT LINES, AS NOTED TO PREPARE THE BUILDING FOR ALL OTHER WORK AS SPECIFIED OR AS SHOWN ON THE DRAWINGS & AS ORDERED BY THE ARCHITECT.
- 4) COMPLY w/ ALL STATE OF RHODE ISLAND DEPARTMENT OF HEALTH STANDARDS DURING DEMOLITION OPERATIONS.
- 5) REMOVE & SALVAGE MATERIAL REQ'D FOR LATER REUSE AS SHOWN ON THE DRAWINGS & AS DIRECTED BY THE ARCHITECT.

**DEMOLITION**

- 4) REMOVE & DISPOSE OF ALL UNSUITABLE MATERIAL OFF SITE. THE OWNER SHALL HAVE RIGHT OF FIRST REFUSAL FOR ALL MATERIALS. REMOVE ANY STOCKPILED MATERIAL DEEMED SURPLUS BY THE ARCHITECT @ NO ADDITIONAL COST TO THE OWNER.
- 5) REFER TO KEYED DEMOLITION NOTES & THE DEMOLITION FLOOR PLAN FOR FURTHER CLARIFICATION OF ITEMS SCHEDULED FOR DEMOLITION.

**DISPOSAL AND CLEAN UP**

- 1) PROMPTLY REMOVE ANY DEMOLITION DEBRIS OR SIMILAR MATERIAL, KEEPING THE AREA CLEAN @ ALL TIMES.

**2) DEMOLISHED MATERIAL**

- 1) ALL DEMOLISHED MATERIAL DECLARED UNSUITABLE BY THE ARCHITECT SHALL BECOME THE PROPERTY OF THE CONTRACTOR & SHALL BE LEGALLY DISPOSED OF OFF THE PREMISES, UNLESS OTHERWISE INDICATED OR SPECIFIED.
- 2) KEEP ALL EXITS, PUBLIC WAYS AND EGRESS PASSAGEWAYS CLEAR OF ALL DEBRIS @ ALL TIMES.
- 3) PREMISES: LEAVE THE PREMISES IN A SAFE, CLEAN & RELATIVELY ORDERLY CONDITION UPON COMPLETION OF WORK.

**FLOOR DEMO NOTES**

**A** REMOVE PARTITION AS INDICATED BY [REDACTED]. REMOVE ALL MECHANICAL, PLUMB & ELEC ITEMS WITHIN (IF EXISTS) & CAP OR ABANDON AS REQ'D.

**A** CUT 86" x 64" OPENING INTO PARTITION. PATCH & PAINT WALL TO MATCH EXISTING. REMOVE & SALVAGE WALL MOUNTED EQUIPMENT (IF EXISTS) FOR REINSTALLATION IN NEW LAYOUT IN COORD w/ OWNER.

**A** REMOVE DOOR, FRAME & ALL RELATED ACCESSORIES.

**A** REMOVE CARPET FLOOR TILE VINYL + WALL BASE IN THIS AREA.

**A** REMOVE VCT FLOORING + WALL BASE IN THIS AREA.


**A** REMOVE & SALVAGE WALL MOUNTED EQUIPMENT AS REQ'D FOR NEW WALL FINISHES.

**A** REMOVE EXIST ELEC FLOOR BOX (10 UNITS). PATCH SLAB AND FLOOR FINISH TO MATCH EXISTING ADJACENT.

**CEILING DEMO NOTES**

**B** REMOVE ENTIRE SUSPENDED CEILING SYSTEM. ALL RECESSED LIGHT FIXTURES, CEILING MOUNTED DEVICES, ESCUTCHEONS, SUPPLY DIFFUSERS & RETURN GRILLES. DUCTWORK ABOVE CEILING SYSTEM TO REMAIN.

**B** REMOVE SOFFIT AS REQ'D TO ACCOMMODATE NEW LAYOUT.

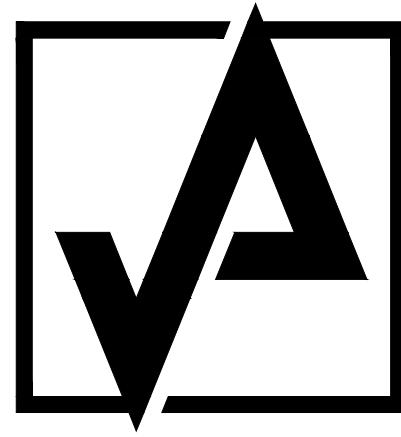

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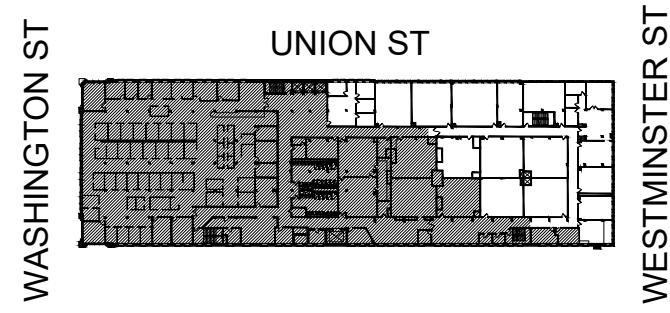
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**FOR CONSTRUCTION**

REVISIONS:		
NUMBER	REMARKS	DATE
2	OWNER + BCC COMMENTS	01/21/2026
3	OWNER COMMENTS	01/27/2026



KEYPLAN

PROJECT TITLE:  
**SHEPARD BUILDING**  
4TH FLOOR RENOVATION

80 WASHINGTON STREET  
PROVIDENCE, RI 02903  
PROVIDENCE COUNTY

DRAWING TITLE:

**DEMOLITION FLOOR PLAN**


DATE: JAN XX, 2026 PROJ NO: 25175

DRAWN BY: AL CHECKED BY: DH

DRAWING NUMBER:

DEMOLITION FLOOR PLAN  
SCALE: 1/8" = 1'-0"

D1.1

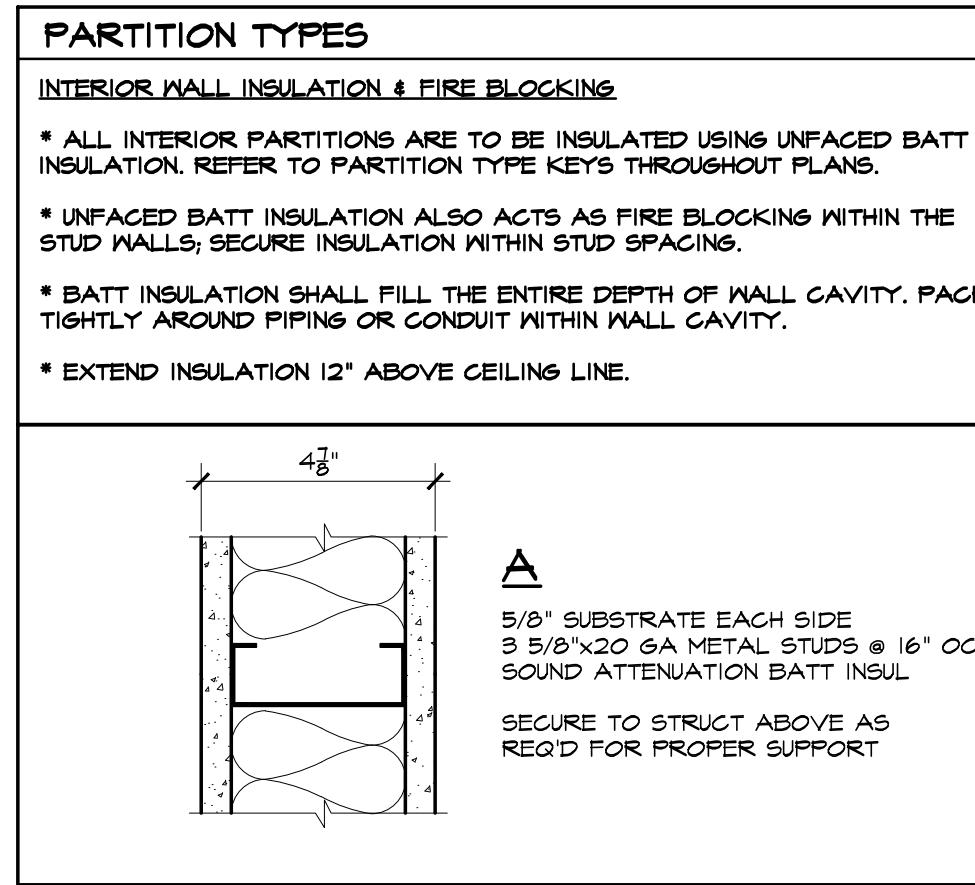

**HARDWARE SETS**

(ALL HARDWARE SHALL BE ADA COMPLIANT WHETHER OR NOT SPECIFIED HEREIN)

**SET 0-1**



- 2 HINGES
- 1 SPRING HINGE
- 1 LOCK SET
- 1 ELECTRIC STRIKE
- 1 CARD READER
- 1 CLOSER
- 1 FLOOR STOP
- 1 SET SILENCERS

**ELECTRICAL WORK NOTE:**

GC SHALL PATCH AND REPAIR ALL AREAS DISTURBED BY ELECTRICAL CUTS OR REMOVAL OF OBSOLETE ITEMS AS REQUIRED TO MATCH THE EXISTING ADJACENT SURFACES.

**DOOR SCHEDULE**

MARK/LOCATION	DOOR						FRAME						HDW	REMARKS	
	NO	ROOM (FROM / TO)	TYPE	WIDTH	HEIGHT	THICK	MAT	FINISH	HEAD DTL	JAMB DTL	SILL DTL	TYPE			MAT
101	SUITE 435 / S. HALLWAY	DI	3'-0"	7'-0"	1 3/4"	WOOD	PAINT	2/A.I.I	2/A.I.I	-	FI	HM	PAINT	O-1	DOOR & FRAME COLOR PAINT TO MATCH EXIST GREEN

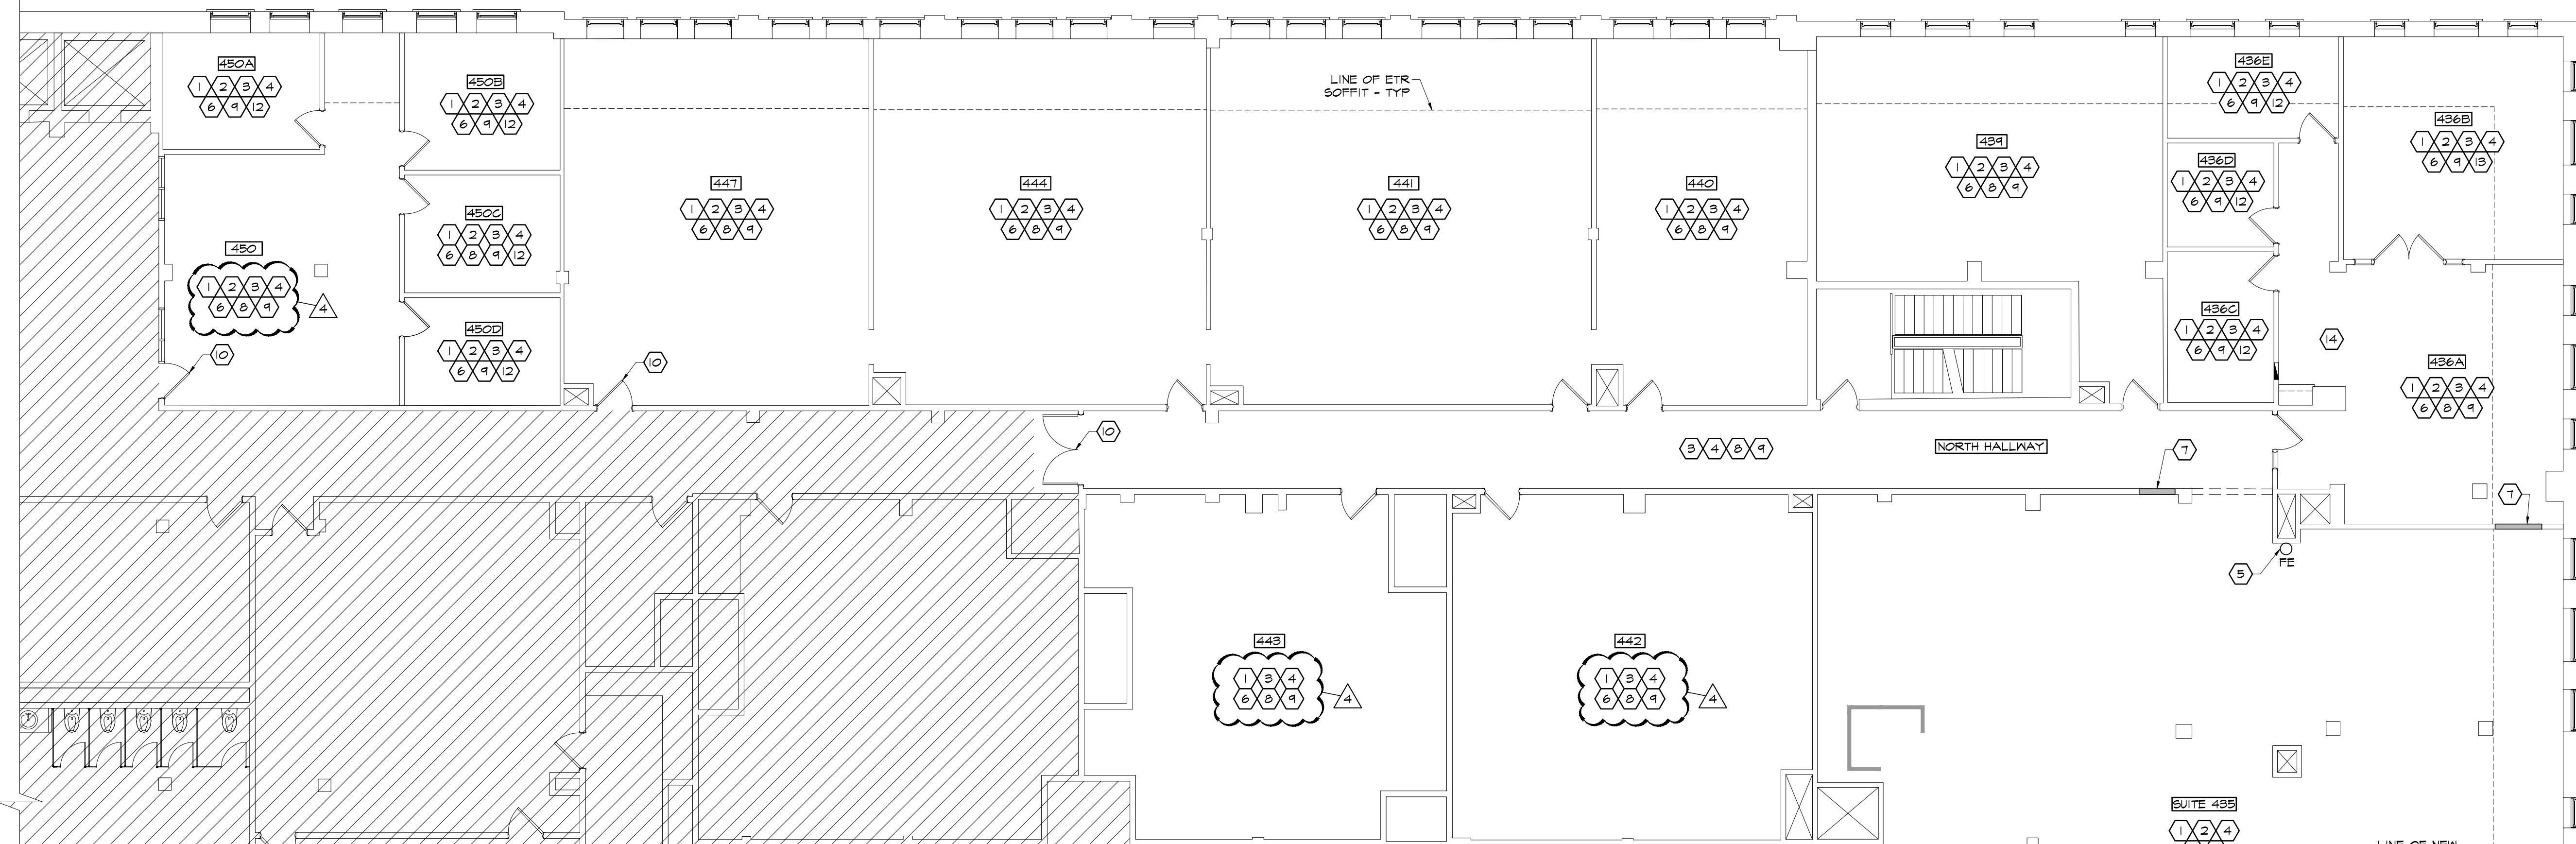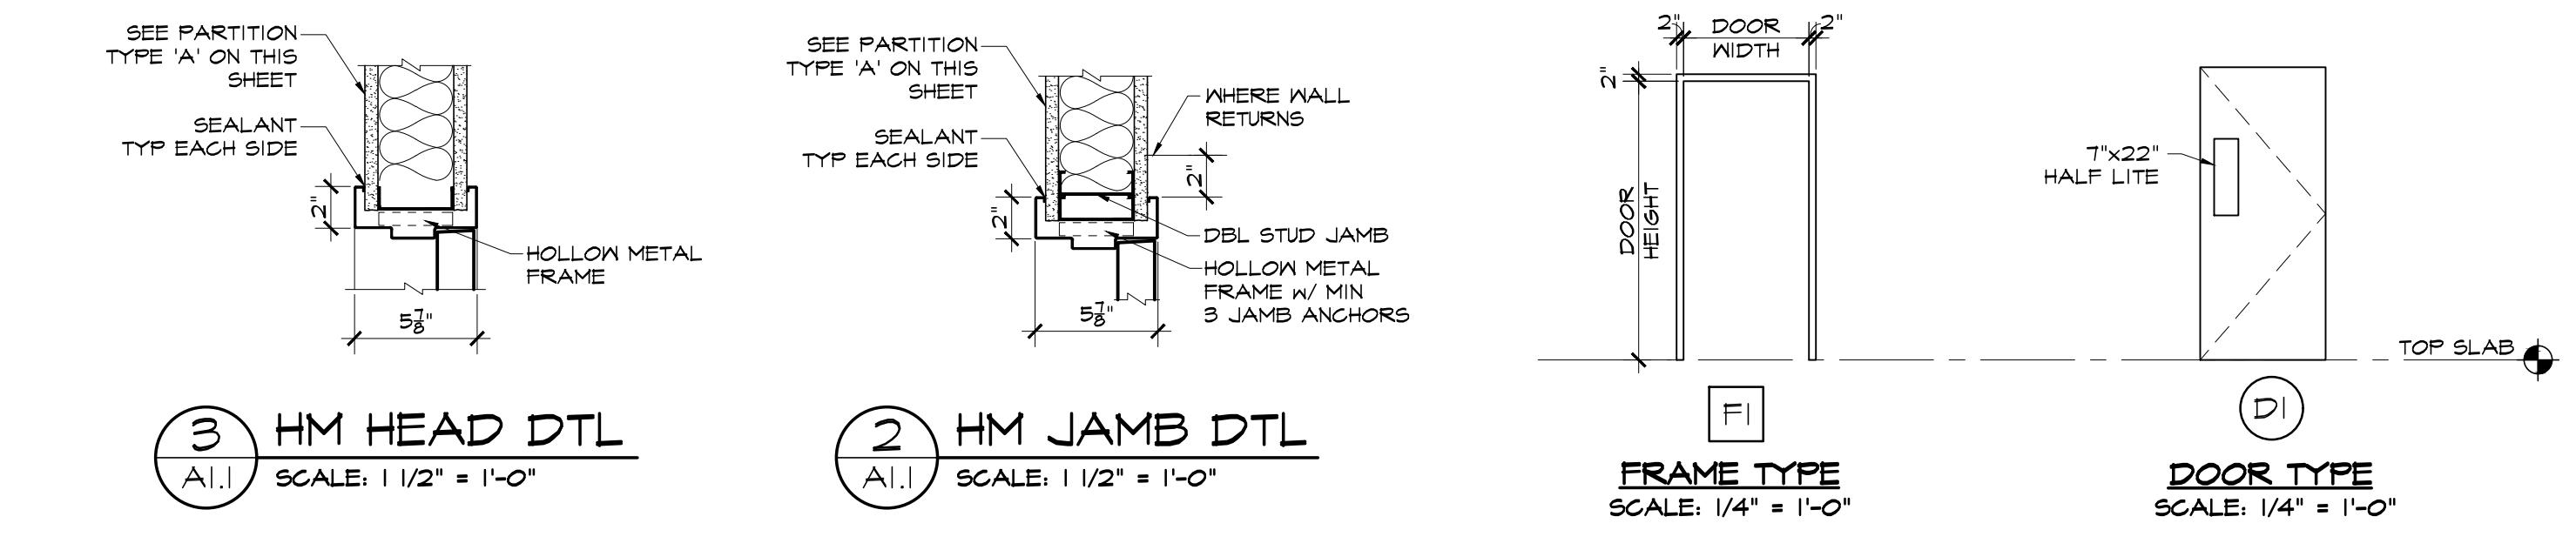

**GENERAL NOTES**

- THE CONTRACTOR SHALL OBTAIN ALL PERMITS & INSPECTIONS NECESSARY TO INSURE ISSUANCE OF AN OCCUPANCY CERTIFICATE UPON COMPLETION OF THE WORK.
- THE CONTRACTOR SHALL MAINTAIN ALL INSURANCE REQ'D BY THE OWNER AND/OR GOVERNMENTAL AUTHORITIES & SHALL PROVIDE PROOF OF SUCH INSURANCE AS REQ'D.
- ALL WORK SHALL BE IN STRICT ACCORDANCE W/ ALL APPLICABLE CODES, CITY OF PROVIDENCE, RHODE ISLAND REGS & AS PUT FORTH IN THESE CONSTRUCTION DOCUMENTS. WHERE CONFLICTS OCCUR, THE MOST STRINGENT REG'S SHALL BE MET.
- THE CONTRACTOR SHALL BE RESPONSIBLE FOR BRACING ALL WORK DURING CONSTRUCTION.
- THE DRAWINGS MAY NOT BE TO SCALE. SEE PLANS & DETAILS FOR DIMENSIONS.
- ALL EXTERIOR DIMENSIONS SHOWN ARE TO THE FACE OF FRAMING. ALL INTERIOR DIMENSIONS SHOWN ARE TO THE FACE OF SUBSTRATE.
- THE CONTRACTOR SHALL VERIFY ALL DIMENSIONS & ELEVATIONS BEFORE COMMENCING CONSTRUCTION & REPORT ANY DISCREPANCIES TO THE ARCHITECT BEFORE PROCEEDING.
- THE CONTRACTOR SHALL ANCHOR WALL MOUNTED EQUIPMENT & ACCESSORIES TO EXISTING WALLS AS REQ'D FOR PROPER SUPPORT. PROVIDE BLOCKING AS REQ'D.
- LEVEL OF GYP BD FINISH PER MATERIAL: UNDER WALL COVERING: 4" UNDER PAINT: 5"
- NOTHING IN THE SPECIFICATIONS OR DRAWINGS SHALL BE CONSTRUED TO ALLOW WORK NOT IN ACCORDANCE W/ THE CODE REGS. WHEN REG'S SHOWN OR SPECIFIED ARE LESS THAN THOSE DICTATED IN THE CODE, THE CONTRACTOR SHALL FURNISH AND/OR INSTALL THE LARGER SIZE OR HIGHER STANDARD WITHOUT EXTRA COST TO THE OWNER.
- "PROVIDE" SHALL MEAN TO "SUPPLY & INSTALL".

**PLUMBING NOTE:**


THE SCOPE OF WORK DOES NOT CARRY ANY PROVISION FOR PLUMBING WORK

**KEYED PLAN NOTES**

- NEW FURNITURE + EQUIPMENT TO BE SUPPLIED BY OWNER AND INSTALLED AS SHOWN IN COORDINATION WITH GC.
- PROVIDE POWER + DATA CONNECTIONS TO NEW FURNITURE + EQUIPMENT. SEE ELEC DWS.
- EXISTING FLOOR AND CEILING FINISHES TO REMAIN IN THIS ROOM. PAINT ALL WALLS W/ MIN 2 COATS OF SHERWIN WILLIAMS PROMAR 200 ZERO VOC INTERIOR LATEX EG-SHEL COLOR TO BE SELECTED BY OWNER. REINSTALL SALVAGED WALL MOUNTED ITEMS BACK TO ORIGINAL LOCATION.
- PAINT ALL WALLS W/ MIN 2 COATS OF SHERWIN WILLIAMS PROMAR 200 ZERO VOC INTERIOR LATEX EG-SHEL - COLOR TO BE SELECTED BY OWNER. REINSTALL SALVAGED WALL MOUNTED ITEMS BACK TO ORIGINAL LOCATION.
- VERIFY LOCATIONS & FUNCTION OF EXISTING FIRE EXTINGUISHERS IN FIELD. IF NONE EXIST OR ARE INOPERABLE, PROVIDE TYPE ABC FIRE EXTINGUISHER, MOUNTED @ 4'-0" AF FROM TOP BY GC. COORDINATE ALL FINAL LOCATIONS & QUANTITY W/ LOCAL FIRE DEPT.
- HANDICAP ACCESSIBLE DESKS & TABLES SHALL BE MAX 34" AF.
- INFILL INTERIOR WALL CONSTRUCTION TO MATCH & ALIGN W/ EXISTING ADJACENT INTERIOR & EXTERIOR FINISHES AS REQ'D.
- PROVIDE 15x15x42" CLEAR POLYCARBONATE CORNER GUARD, TYPICAL AT ALL OUTSIDE WALL CORNERS.
- PROVIDE BLOCKING IN WALL/CEILING & EQUIPMENT MOUNTING LOCATIONS. SEE ELEC DWS - TYP. GC SHALL COORD W/ OWNER FOR TVs, BOARDS, SIGNS, ETC FINAL PLACEMENT.
- PROVIDE ELEC TO EXISTING DOOR FOR FUTURE ACCESS CONTROL BY OWNER. GC SHALL COORD POWER LOCATION W/ OWNER.
- PROVIDE POWER + DATA FLOOR BOX CENTERED UNDERNEATH CONFERENCE TABLE AND INTERCONNECTED WITH MONITOR AT WALL - SEE ELEC DWS.
- ALT #1 - PROVIDE POWER + DATA OUTLETS INSTALLED IN COORDINATION W/ NEW ROOM - SEE ELEC DWS.
- ALT #2 - PROVIDE POWER + DATA FLOOR BOX CENTERED UNDERNEATH CONFERENCE TABLE AND INTERCONNECTED WITH MONITOR AT WALL - SEE ELEC DWS.
- SEE ELEC DWS FOR TIME CLOCK PANEL INSTALLATION IN THIS ROOM. PROVIDE BLOCKING, PATCH AND PAINT DISTURBED AREA AS REQ'D TO MATCH EXIST ADJACENT.

1

**FLOOR PLAN**  
SCALE: 1/8" = 1'-0"

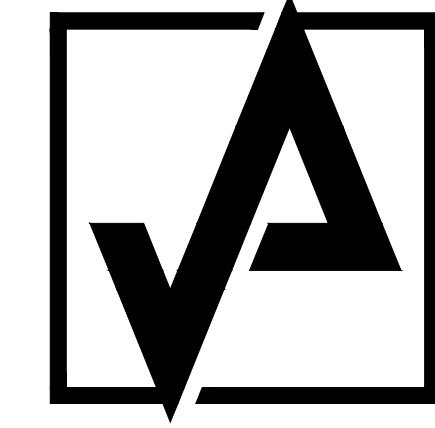

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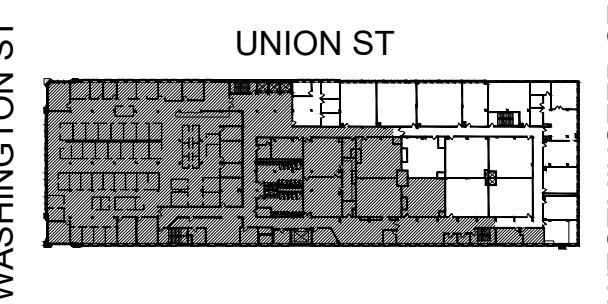
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**FOR CONSTRUCTION**

**REVISIONS:**

NUMBER	REMARKS	DATE
1	BCC COMMENTS	01/02/2026
2	OWNER + BCC COMMENTS	01/21/2026
4	OWNER COMMENTS	02/02/2026



**PROJECT TITLE:**  
**SHEPARD BUILDING**

**4TH FLOOR RENOVATION**

**80 WASHINGTON STREET**  
**PROVIDENCE, RI 02903**  
**PROVIDENCE COUNTY**

**DRAWING TITLE:**  
**FLOOR PLAN, DOOR & STOREFRONT SCHEDULE & DETAILS**

**DATE:** JAN XX, 2026 **PROJ NO:** 25175


**DRAWN BY:** AL **CHECKED BY:** DH

**DRAWING NUMBER:**

**A1.1**  
PLAN


FLOOR FINISH SCHEDULE (SEE PROJECT MANUAL FOR ADDITIONAL INFORMATION)			
CODE	MATERIAL	MANUFACTURER	DESCRIPTION/REMARKS
CPT-01	CARPET TILE	FORBO	BASIS OF DESIGN: 19.6" x 19.6" FLOTEX COLOUR COLLECTION - COLOR TO BE SELECTED BY OWNER
CPT-02	CARPET TILE	MATCH EXISTING	MATCH EXISTING CARPET AT ROOM #450
VB-01	VINYL WALL BASE	JOHNSONITE	4" TRADITIONAL VINYL 1/8" - COLOR TO BE SELECTED BY OWNER
VB-02	VINYL WALL BASE	MATCH EXISTING	MATCH EXISTING VINYL BASE AT ROOM #450

## LEGEND

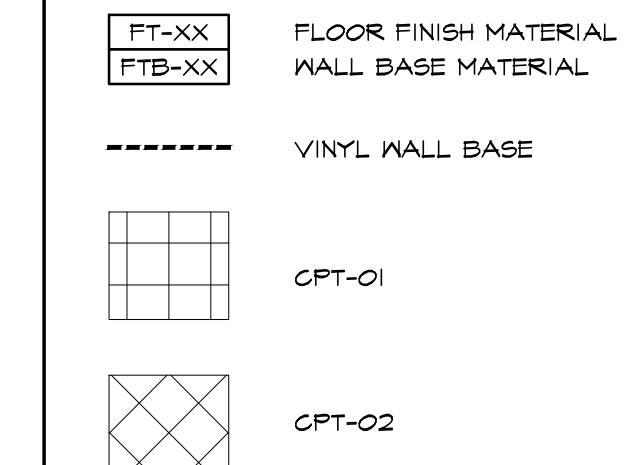

## KEYED PLAN NOTES

- ① EXISTING CARPET TILE + VINYL WALL BASE TO REMAIN IN THIS ROOM.
- ② INSTALL CARPET TILE AS SHOWN, BASIS OF DESIGN: FLOTEX COLOUR - COLOR TO BE SELECTED BY OWNER.
- ③ INSTALL CARPET TILE TO MATCH + ALIGN WITH ROOM #450 EXIST CARPET.
- ④ PATCH EXIST CARPET AND/OR WALL BASE AS REQUIRED TO ACCOMMODATE NEW LAYOUT.
- ⑤ TILE WORK POINT.
- ⑥ PROVIDE ALUM TRANSITION STRIP AT CARPET TILES TRANSITION.
- ⑦ IF REQUIRED, PATCH EXIST CARPET TILE DAMAGED DURING CONSTRUCTION WORK.

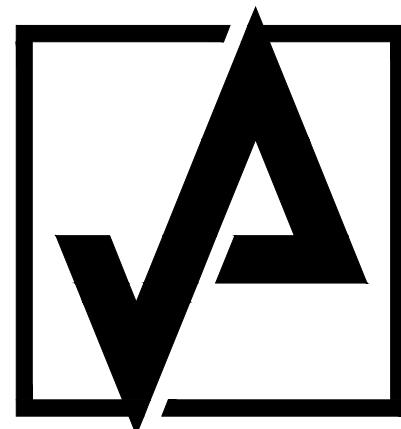


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1 FLOOR FINISH PLAN  
SCALE: 1/8" = 1'-0"



KEYPLAN

PROJECT TITLE:  
**SHEPARD BUILDING**  
4TH FLOOR RENOVATION

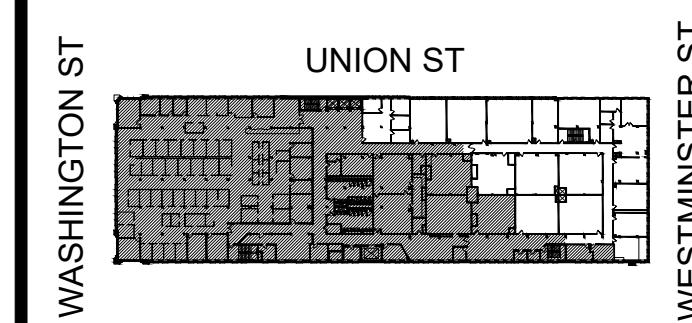80 WASHINGTON STREET  
PROVIDENCE, RI 02903  
PROVIDENCE COUNTY

DRAWING TITLE:  
**FLOOR FINISH  
PLAN & DETAILS**

DATE: JAN XX, 2026 PROJ NO: 25175

DRAWN BY: AL CHECKED BY: DH

DRAWING NUMBER:

**A1.2**




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## FOR CONSTRUCTION

REVISIONS:		
NUMBER	REMARKS	DATE
2	OWNER + BCC COMMENTS	01/21/2026

KEYPLAN



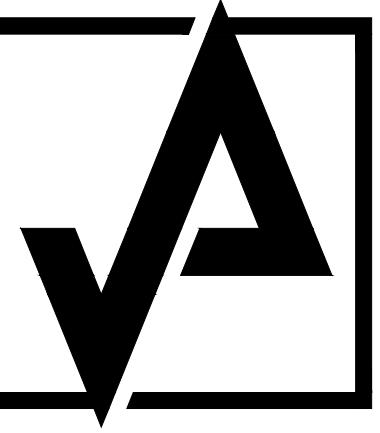

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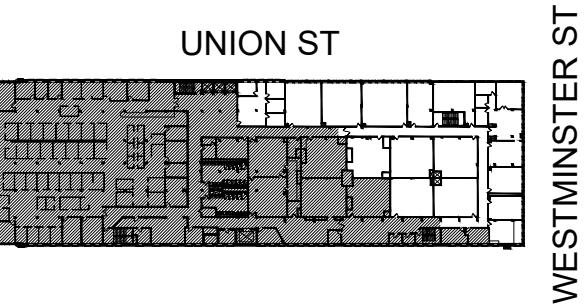
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FOR CONSTRUCTION

REVISIONS:		
NUMBER	REMARKS	DATE
2	OWNER COMMENTS	01/21/2026
3	OWNER COMMENTS	01/27/2026
4	OWNER COMMENTS	02/02/2026




PROJECT TITLE:  
**SHEPARD BUILDING**  
4TH FLOOR RENOVATION

80 WASHINGTON STREET  
PROVIDENCE, RI 02903  
PROVIDENCE COUNTY

DRAWING TITLE:  
**FURNITURE PLAN & ADA COMPLIANCE**

DATE: JAN XX, 2026 PROJ NO: 25175  
DRAWN BY: AL CHECKED BY: DH  
DRAWING NUMBER: A1.4

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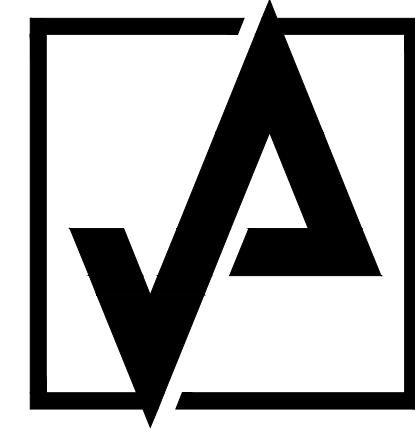
FURNITURE PLAN  
SCALE: 1/8" = 1'-0"  
 PLAN

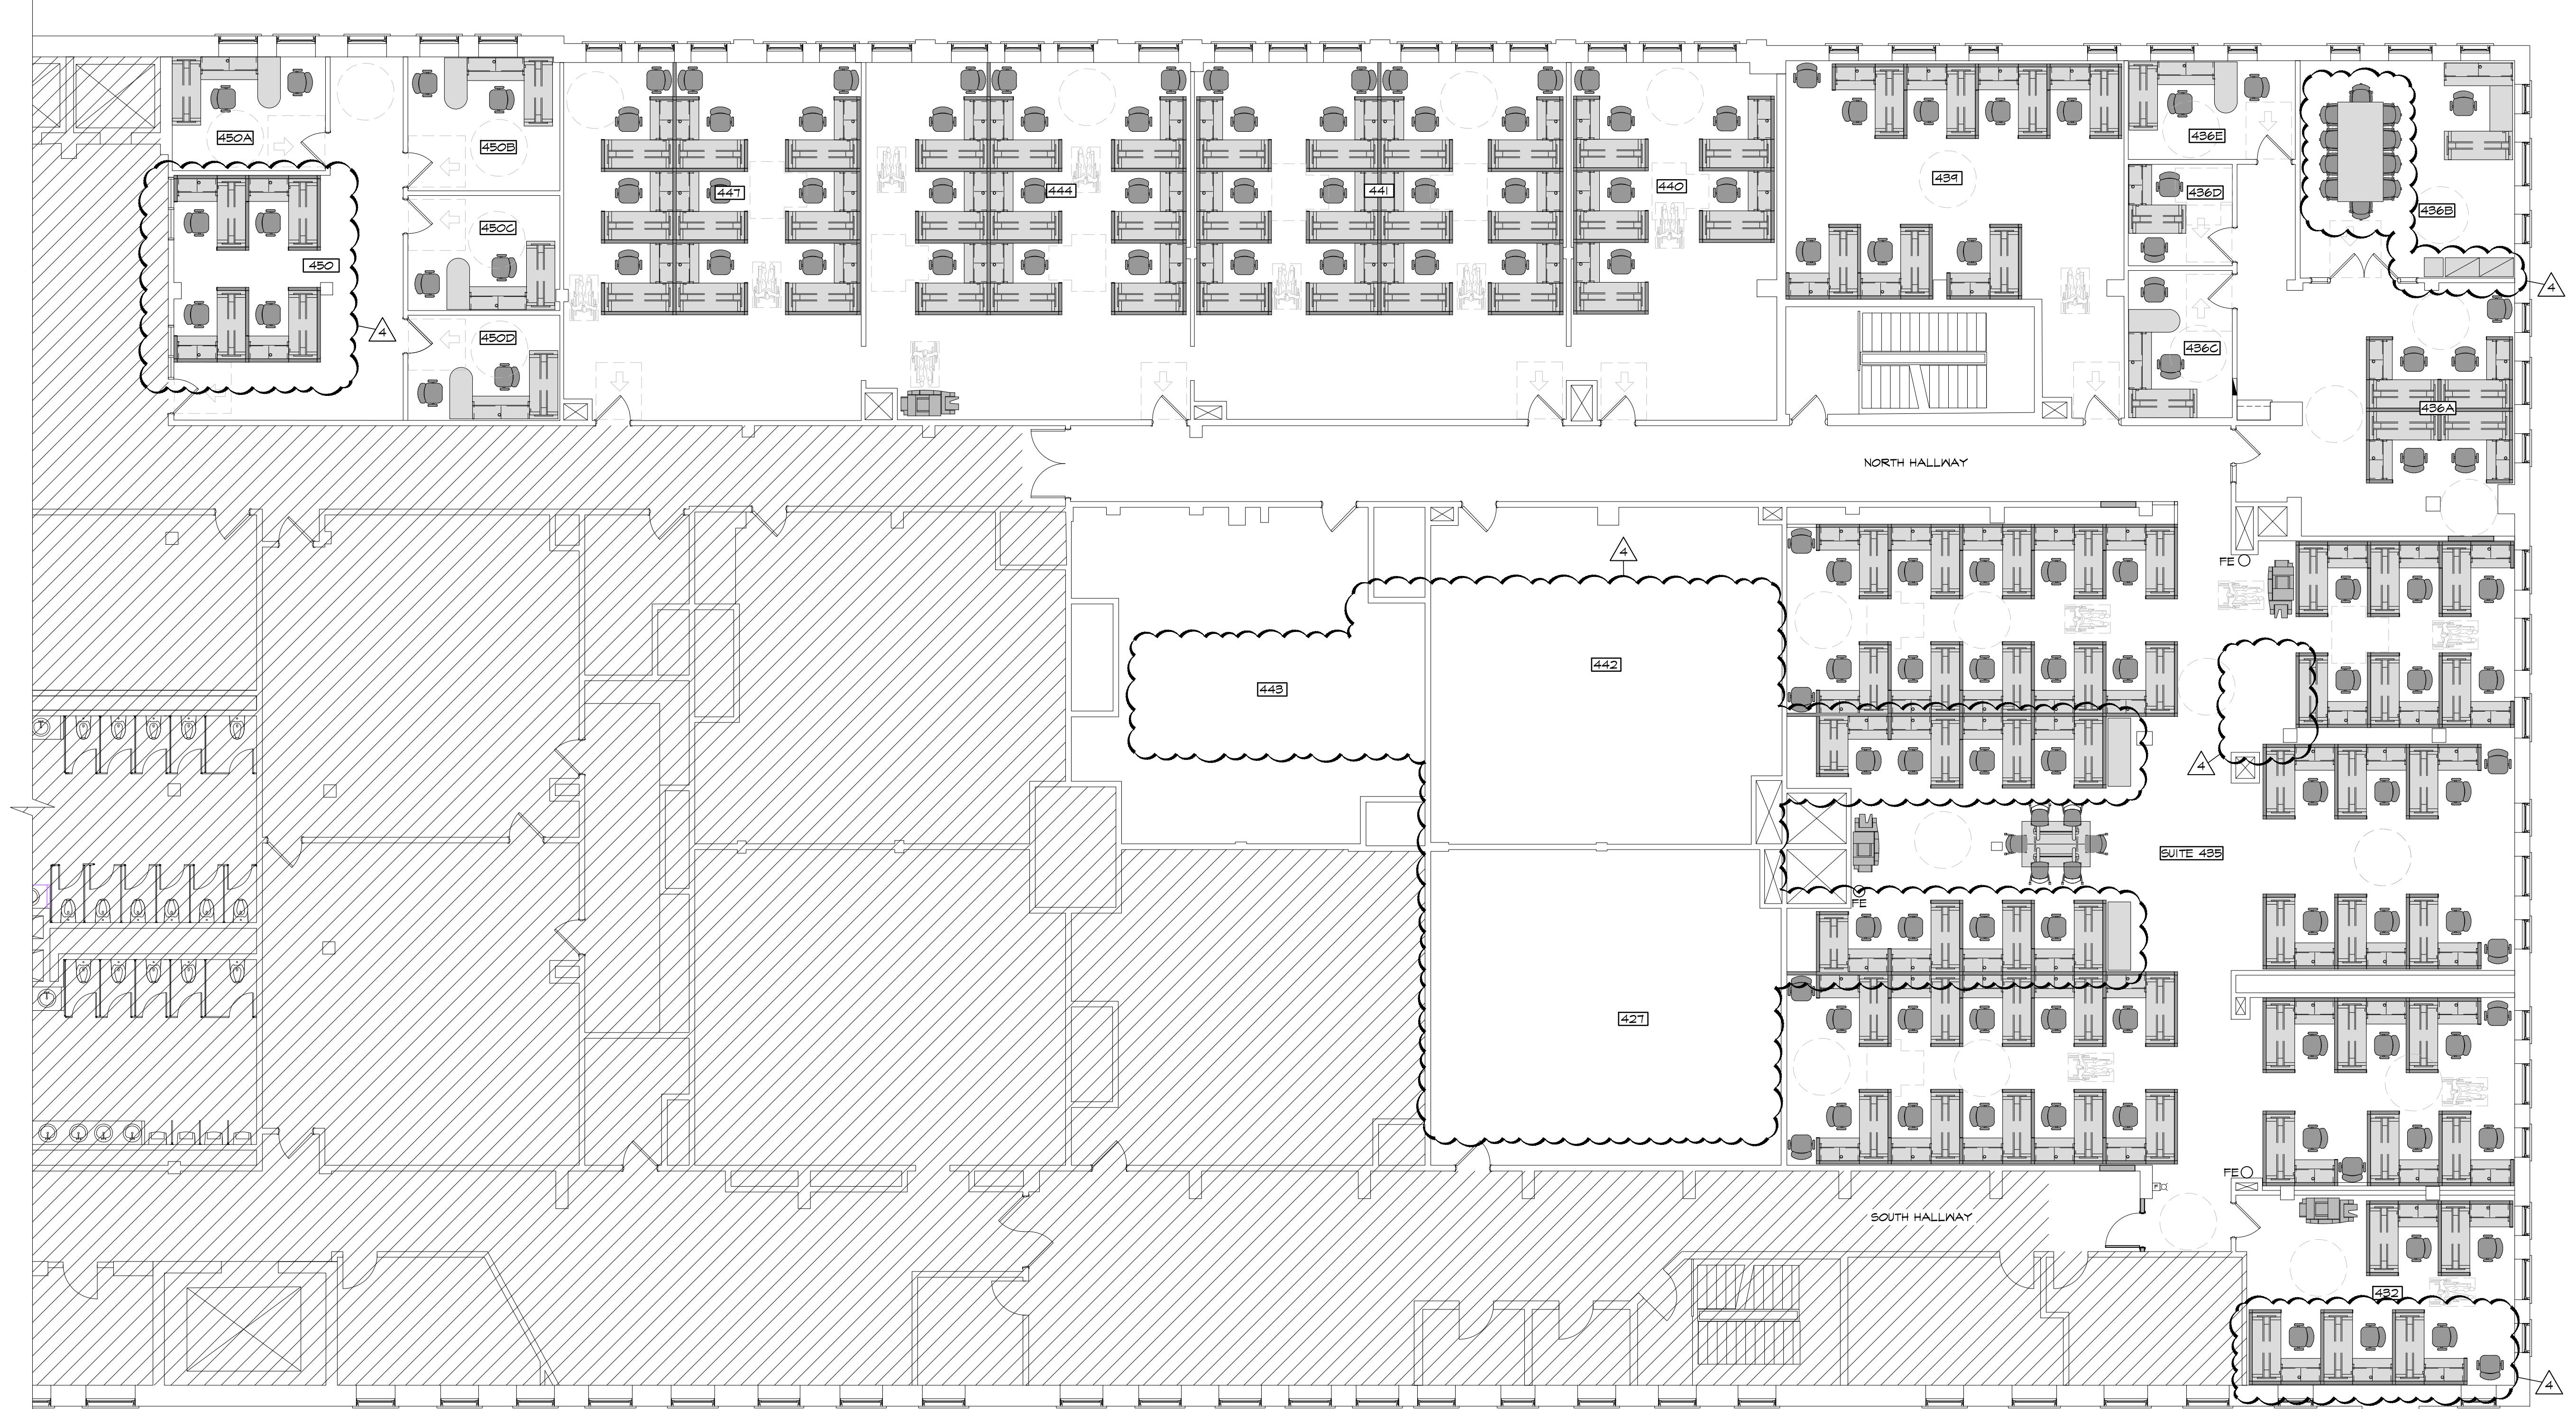**A1.4**

# SHEPARD BUILDING 4TH FLOOR RENOVATION

## 80 WASHINGTON STREET PROVIDENCE, RI 02903

### ELECTRICAL DRAWINGS




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FOR CONSTRUCTION

REVISIONS:		
NUMBER	REMARKS	DATE
1	FOR PERMIT	01-02-2026
2	FOR CONSTRUCTION	01-16-2026
3	OWNER COMMENTS	01-27-2026
4	OWNER COMMENTS	02-02-2026



KEYPLAN

PROJECT TITLE:  
SHEPARD BUILDING  
4TH FLOOR RENOVATION

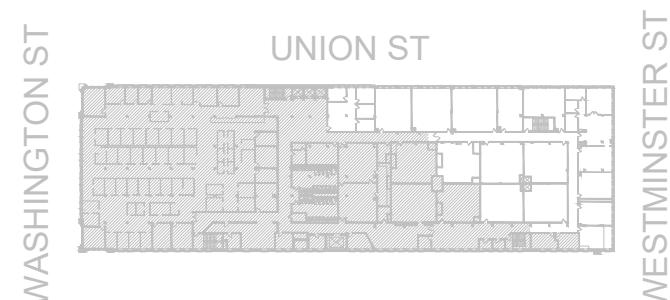80 WASHINGTON STREET  
PROVIDENCE, RI 02903  
PROVIDENCE COUNTY

DRAWING TITLE:  
ELECTRICAL COVER SHEET

DATE: 01-27-2026 PROJ NO: 25019.000

DRAWN BY: MR CHECKED BY: JWM

DRAWING NUMBER:


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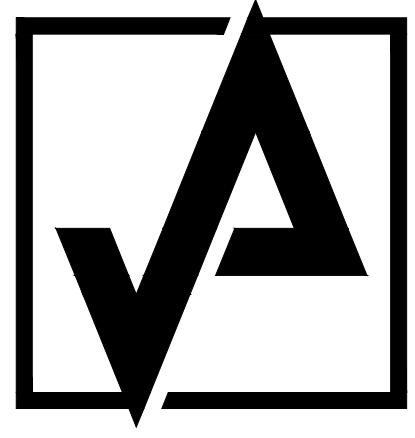
SCOPE OF WORK SUMMARY					
THIS ELECTRICAL DRAWING PACKAGE HAS BEEN PREPARED TO DOCUMENT AND SUPPORT THE RENOVATION OF EXISTING OFFICE AND CLASSROOM SPACE AT THE SHEPARD BUILDING PROJECT. THE SCOPE OF THIS PACKAGE IS LIMITED TO THE ELECTRICAL ENGINEERING DESIGN NECESSARY TO ACCOMMODATE THE NEW ARCHITECTURAL AND FURNITURE LAYOUTS, COVERING FIRE ALARM, POWER, LIGHTING, AND CONTROLS.					
<b>WORK CONTAINED IN THIS PACKAGE</b>					
<ul style="list-style-type: none"> <li>— NEW POWER DISTRIBUTION TO FURNITURE WORKSTATIONS SUPPLIED BY THE OWNER.</li> <li>— RELOCATION AND REPROGRAMMING OF EXISTING LIGHTING FIXTURES.</li> <li>— NEW LIGHTING CONTROL ZONES.</li> <li>— NEW RECEPTACLE CONTROL PER IECC 2024 REQUIREMENTS.</li> <li>— REUSE OF EXISTING PANELBOARDS FOR NEW BRANCH CIRCUITING.</li> </ul>					
<b>COORDINATION AND ADDITIONAL DOCUMENTS:</b>					
<ul style="list-style-type: none"> <li>— COORDINATION WITH THE FURNITURE WORKSTATION VENDOR.</li> </ul>					

DWG#	DRAWING NAME	REV	REV	REV	REV
E0.1	ELECTRICAL COVER SHEET	1	2	3	4
E1.1	ELECTRICAL POWER, FIRE ALARM, & SYSTEMS PLAN - DEMOLITION	1	2	3	4
E1.2	ELECTRICAL POWER, FIRE ALARM, & SYSTEMS PLAN - NEW WORK	1	2	3	4
E2.1	ELECTRICAL LIGHTING PLAN - DEMOLITION	1	2	3	N/A
E2.2	ELECTRICAL LIGHTING PLAN - NEW WORK	1	2	3	N/A
E3.1	ELECTRICAL SCHEDULES AND DETAILS	1	2	3	4
E3.2	ELECTRICAL DAYLIGHT ZONING AND LIGHTING CONTROLS SEQUENCES	1	2	3	N/A








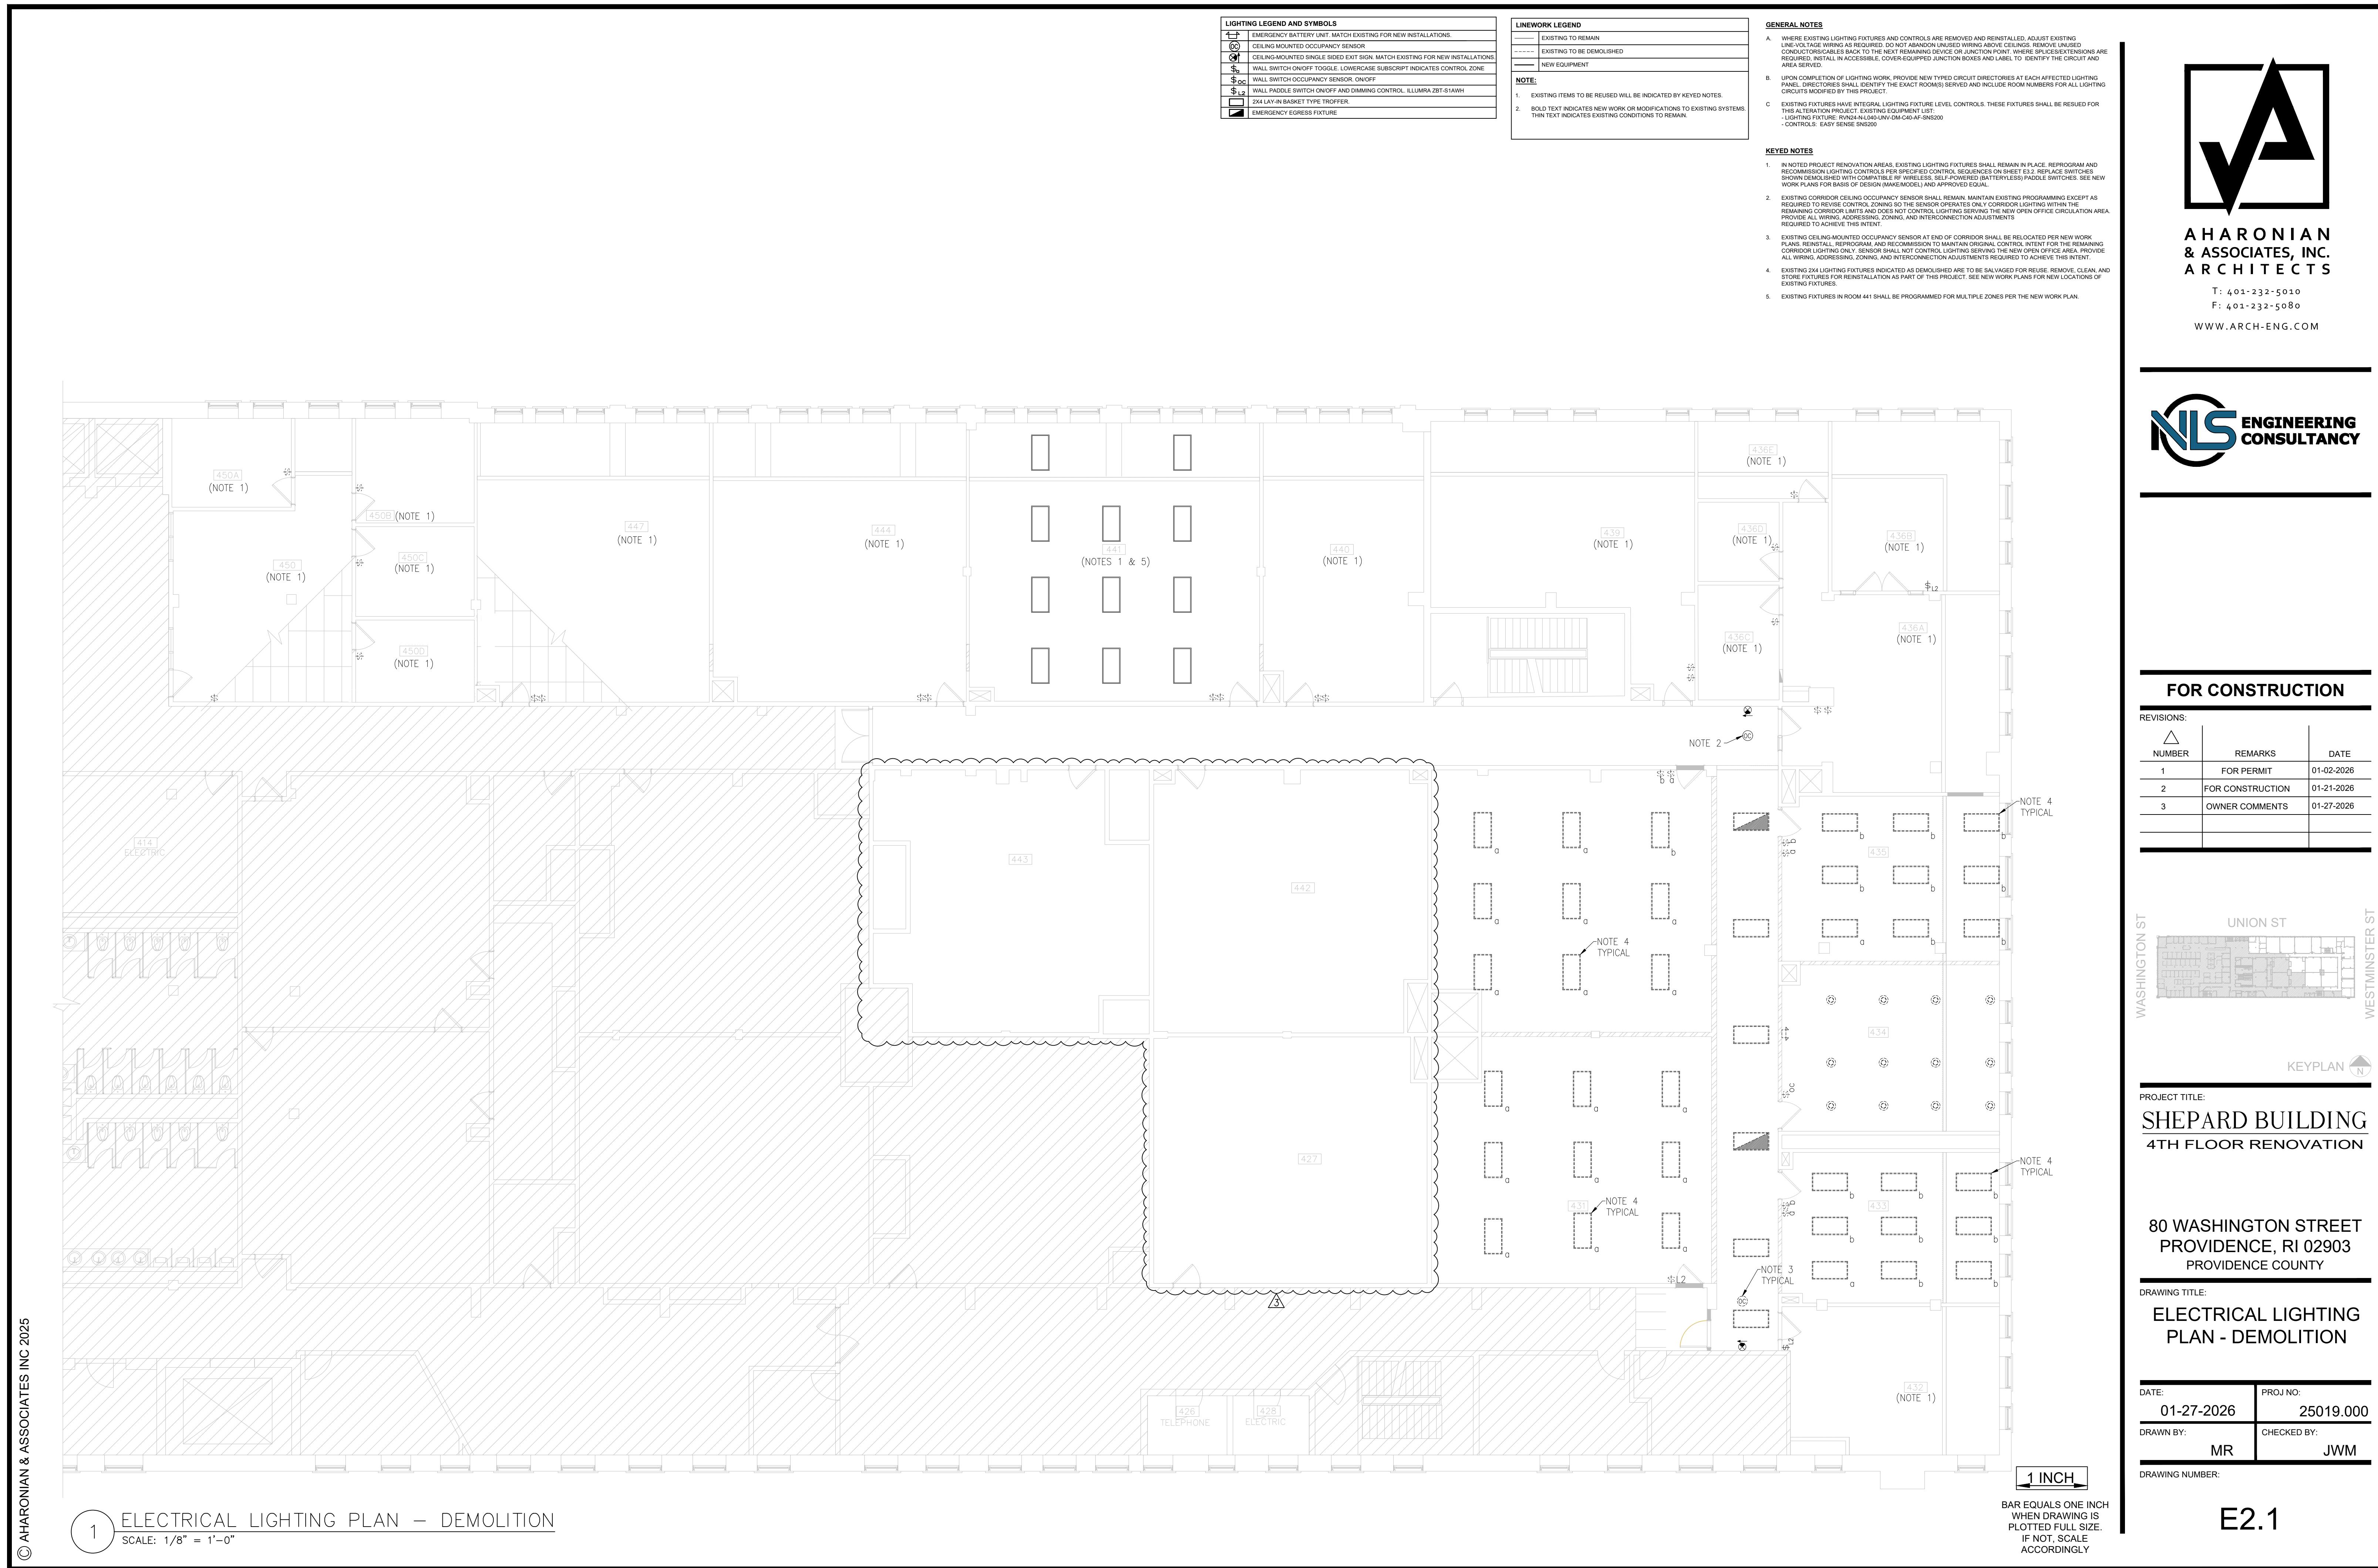

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2	FOR CONSTRUCTION	01-21-2026
3	OWNER COMMENTS	01-27-2026

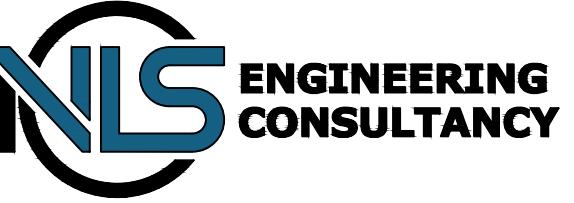

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PROJECT TITLE:

# SHEPARD BUILDING

## 4TH FLOOR RENOVATION

80 WASHINGTON STREET  
PROVIDENCE, RI 02903  
PROVIDENCE COUNTY

DRAWING TITLE:

# ELECTRICAL LIGHTING PLAN - NEW WORK

DATE:	PROJ NO:
01-27-2026	25019.000
DRAWN BY:	CHECKED BY:
MR	JWM

DRAWING NUMBER:

AR EQUALS ONE INCH  
WHEN DRAWING IS  
PLOTTED FULL SIZE.  
IF NOT, SCALE  
ACCORDINGLY

**F2.2**

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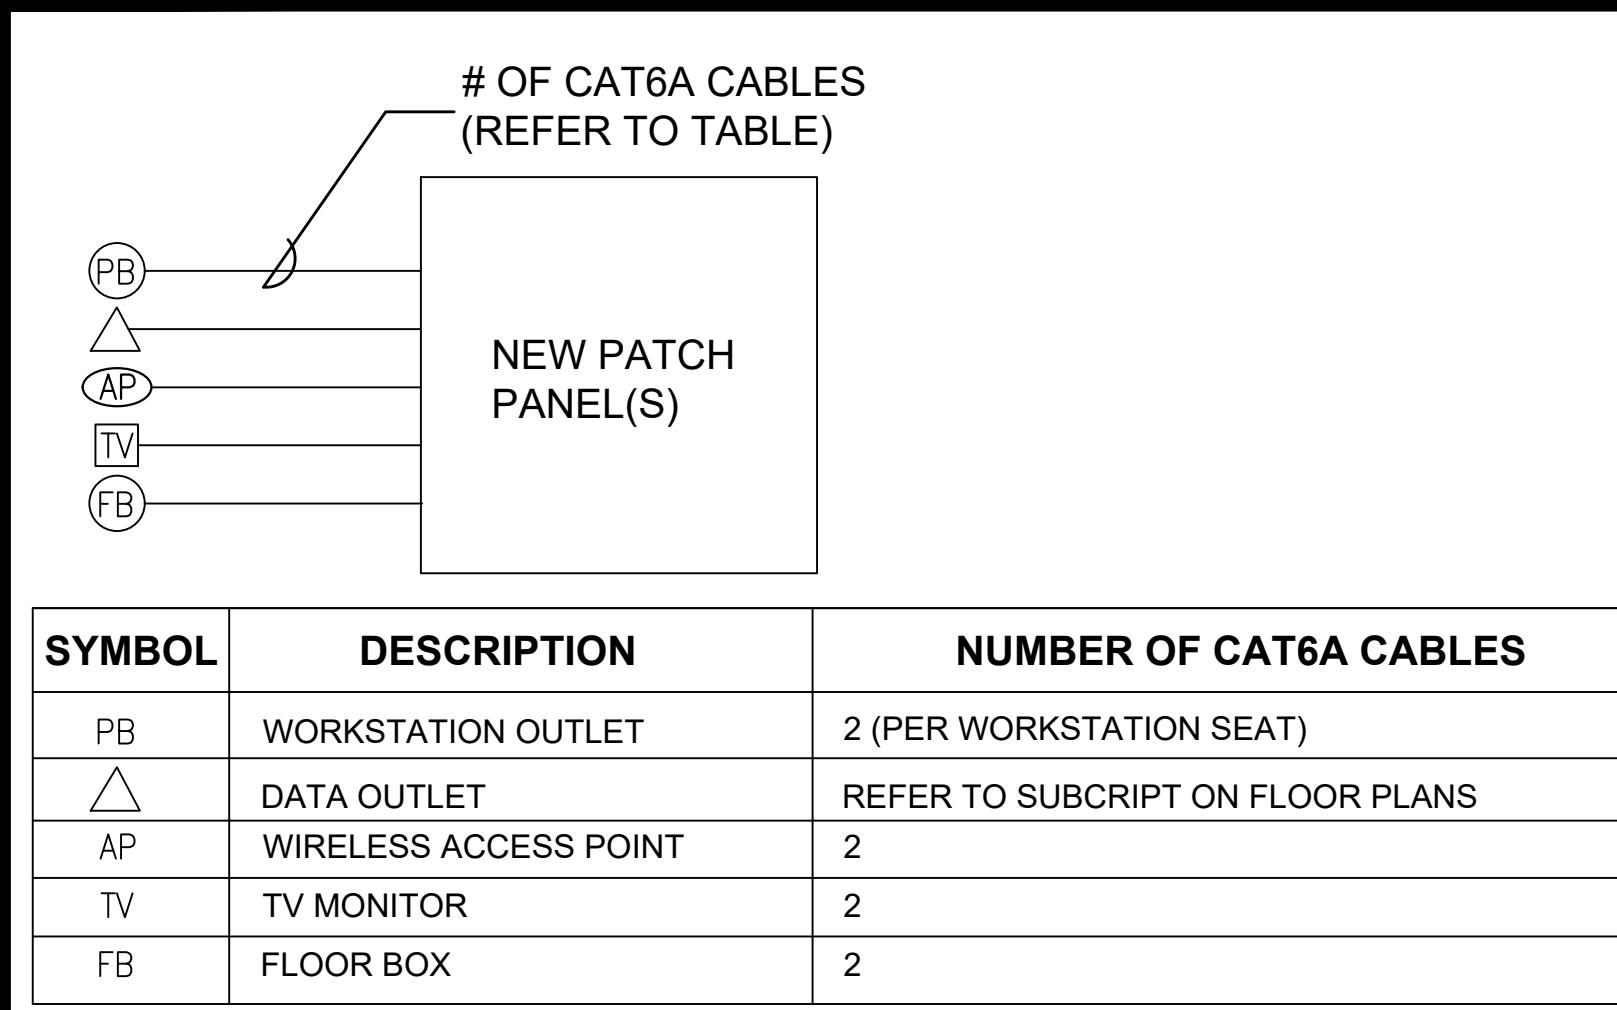
1 ELECTRICAL LIGHTING PLAN - NEW WORK  
SCALE: 1/8" = 1'-0"

1 ELECTRICAL  
SCALE: 1/8" = 1'-0"

1 ELECTRICAL LIGHTING PLAN - NEW WORK  
SCALE:  $1/8" = 1'-0"$

BAR EQUALS ONE INCH  
WHEN DRAWING IS  
PLOTTED FULL SIZE  
INCHES  
SCALE  
ACCORDINGLY

E22



#### NOTES:

1. FOR BIDDING PURPOSES, PROVIDE FOUR (4) NEW 48-PORT PATCH PANELS MATCHING EXISTING MAKE AND MODEL OF OWNER EQUIPMENT. INSTALL INTO EXISTING RACKS (NO NEW RACKS REQUIRED).
2. PROVIDE PATCH PANELS MATCHING EXISTING SIEMON EQUIPMENT.
3. LABEL ALL DATA CABLES END-TO-END AT PATCH PANEL TERMINATIONS AND FACEPLATES. COORDINATE WITH OWNER'S IT STAFF TO DETERMINE LABELING SYSTEM MATCHING EXISTING STANDARDS AND IMPLEMENT APPROVED SYSTEM.
4. THE PROJECT INCLUDES INSTALLATION, TERMINATION, TESTING AND COMMISSIONING OF ALL CAT6A CABLING.

### ③ LOW-VOLTAGE CAT6A CABLING INTERCONNECTION BLOCK DIAGRAM

#### AUTOMATIC RECEPTACLE CONTROL SEQUENCE

##### SCOPE & COMPLIANCE STRATEGY

- SCOPE OF CONTROL: AUTOMATIC CONTROL SHALL BE APPLIED TO RECEPTACLES LOCATED WITHIN THE MODULAR FURNITURE WORKSTATIONS AND SPLIT CONTROLLED RECEPTACLES AS DEFINED BELOW.
- EXISTING CONDITIONS: EXISTING WALL-MOUNTED CONVENIENCE RECEPTACLES IN AREA OF BRANCH CIRCUIT MODIFICATION SHALL BE REPLACED WITH SPLIT WIRE CONTROLLED RECEPTACLES AND PROVIDED WITH A SWITCHED HOT LEG TIED TO THE TIME CLOCKS.

##### SYSTEM ARCHITECTURE

- METHOD: CONTROL SHALL BE ACHIEVED VIA A CENTRALIZED TIME-CLOCK SCHEDULE (RELAY PANEL OR LIGHTING CONTROL SYSTEM) SWITCHING THE DESIGNATED "CONTROLLED" LEG OF THE BRANCH CIRCUITS SERVING THE FURNITURE SYSTEMS.
- MARKING: CONTROLLED RECEPTACLES AT THE WORKSTATION FACEPLATES SHALL BE PERMANENTLY MARKED WITH THE STANDARD SYMBOL OR THE WORD "CONTROLLED" TO INDICATE AUTOMATIC SHUTOFF CAPABILITY.

##### SCHEDULED OPERATION (TIME-OF-DAY)

- NORMAL BUSINESS HOURS: FURNITURE CIRCUITS AND SPLIT CONTROLLED RECEPTACLES SHALL BE ENERGIZED (ON) AUTOMATICALLY ACCORDING TO THE PROGRAMMED SCHEDULE.
- AFTER HOURS / VACANCY: AT THE END OF THE SCHEDULED "ON" PERIOD, THE "SWITCHED" POWER LEG SHALL AUTOMATICALLY TURN OFF.
- WEEKEND / HOLIDAY: SWITCHED POWER SHALL REMAIN OFF FOR 24 HOURS UNLESS MANUALLY OVERRIDDEN.

##### LOCAL MANUAL OVERRIDE SEQUENCE

- REQUIREMENT: PROVIDE A READILY ACCESSIBLE MANUAL OVERRIDE SWITCH LOCATED WITHIN EACH OPEN OFFICE ZONE OR CLUSTER OF WORKSTATIONS. REFER TO PLANS FOR PROPOSED LOCATIONS.
- SEQUENCE: ACTIVATING THE LOCAL MANUAL OVERRIDE SWITCH SHALL ENERGIZE THE "SWITCHED" FURNITURE FEEDS AND CONTROLLED RECEPTACLES IN THAT SPECIFIC ZONE. REFER TO THE "TIME CLOCK LOAD CONTROL SCHEDULE" THIS DRAWING.
- DURATION: THE OVERRIDE SHALL REMAIN ACTIVE FOR A MAXIMUM OF 2 HOURS.
- EXPIRATION: AFTER 2 HOURS, THE SYSTEM SHALL AUTOMATICALLY TURN THE CIRCUITS OFF AGAIN UNLESS THE OVERRIDE IS RE-ACTIVATED.

##### INITIAL PROGRAMMING STRATEGY (DEFAULT SETTINGS)

###### MONDAY – FRIDAY:

- AUTO-ON: 6:00 AM
- AUTO-OFF: 7:00 PM

###### SATURDAY – SUNDAY:

- STATUS: OFF (24 HOURS)

###### HOLIDAYS:

- STATUS: OFF (24 HOURS)

###### OVERRIDE DURATION: 2 HOURS

##### FURNITURE CONNECTION REQUIREMENTS (MULTI-CONDUCTOR FEED)

- CIRCUITING: CONTRACTOR SHALL PROVIDE A MULTI-CONDUCTOR HOMERUN (CONSTANT HOT, SWITCHED HOT, NEUTRAL, GROUND) FROM THE RELAY PANEL/CONTROLLER TO THE DESIGNATED FURNITURE FEED J-BOX TO PROVIDE OPTIONALITY FOR SEPARATE CONTROL.
- WIRING LOGIC: CONSTANT CONDUCTOR: BYPASSES THE TIME-CLOCK RELAY (24/7 POWER). SWITCHED CONDUCTOR: ROUTED THROUGH THE RELAY (SCHEDULED CONTROL).
- FURNITURE CONNECTION (FIELD COORDINATION): CONTRACTOR SHALL COORDINATE WITH THE FURNITURE INSTALLER TO DETERMINE THE CAPABILITIES OF THE FURNITURE ELECTRICAL WHIP (IN-FEED).
- OPTION A (SPLIT-WIRE WHIP): IF FURNITURE ACCEPTS DUAL INPUTS, CONNECT THE "CONSTANT" CONDUCTOR TO THE COMPUTER/CRITICAL CIRCUIT AND THE "SWITCHED" CONDUCTOR TO THE GENERAL UTILITY CIRCUIT.
- OPTION B (SINGLE-WIRE WHIP): IF FURNITURE ACCEPTS ONLY A SINGLE INPUT, CAP THE "CONSTANT" CONDUCTOR AND CONNECT THE "SWITCHED" CONDUCTOR TO THE WHIP TO CONTROL THE ENTIRE WORKSTATION.


##### COMMISSIONING REQUIREMENTS

- COMMISSIONING IS REQUIRED FOR ALL RECEPTACLE CONTROLS IN ACCORDANCE WITH IECC 2024 SECTION C408. REFER TO THE PROJECT SPECIFICATIONS.

### ② AUTOMATIC RECEPTACLE CONTROL SEQUENCES

TIME CLOCK LOAD CONTROL SCHEDULE (NOTE 6)					
PANELBOARD	BRANCH CIRCUIT	LOAD DESCRIPTION	TIME CLOCK ID	OVERRIDE ID	ROOM NO.
LP1	21	FURNITURE WORKSTATIONS	TC-3	OR-5	436A
LP1	22, 23	FURNITURE WORKSTATIONS	TC-3	OR-4	SUITE 435
NOTE 4		SPLIT WIRED RECEPTACLE	TC-3	OR-5	436A
LP4A	10, 12, 18, 19, 21	FURNITURE WORKSTATIONS	TC-1	OR-1	441, 444, 447
LP4A	23	FURNITURE WORKSTATIONS	TC-1	OR-4	SUITE 435
LP4B	1, 10	FURNITURE WORKSTATIONS	TC-2	OR-1	440, 441
LP4B	9, 12	FURNITURE WORKSTATIONS	TC-2	OR-2	439
LP4B	4, 7, 14, 21, 22, 25	FURNITURE WORKSTATIONS	TC-2	OR-4	SUITE 435
LP4B	30	FURNITURE WORKSTATIONS	TC-2	OR-6	432
LP4B	26	SPLIT WIRED RECEPTACLE	TC-2	OR-6	432
NOTE 4		SPLIT WIRED RECEPTACLE	NOTE 5	OR-4	SUITE 435
NOTE 4		SPLIT WIRED RECEPTACLE	NOTE 5	OR-4	SUITE 435
NOTE 4		SPLIT WIRED RECEPTACLE	NOTE 5	OR-4	SUITE 435
NOTE 4		SPLIT WIRED RECEPTACLE	NOTE 5	OR-2	439
NOTE 4		SPLIT WIRED RECEPTACLE	NOTE 5	OR-1	440, 441
NOTE 4		SPLIT WIRED RECEPTACLE	NOTE 5	OR-1	444, 447


NOTE 4 FURNITURE WORKSTATIONS NOTE 5 OR-1 450

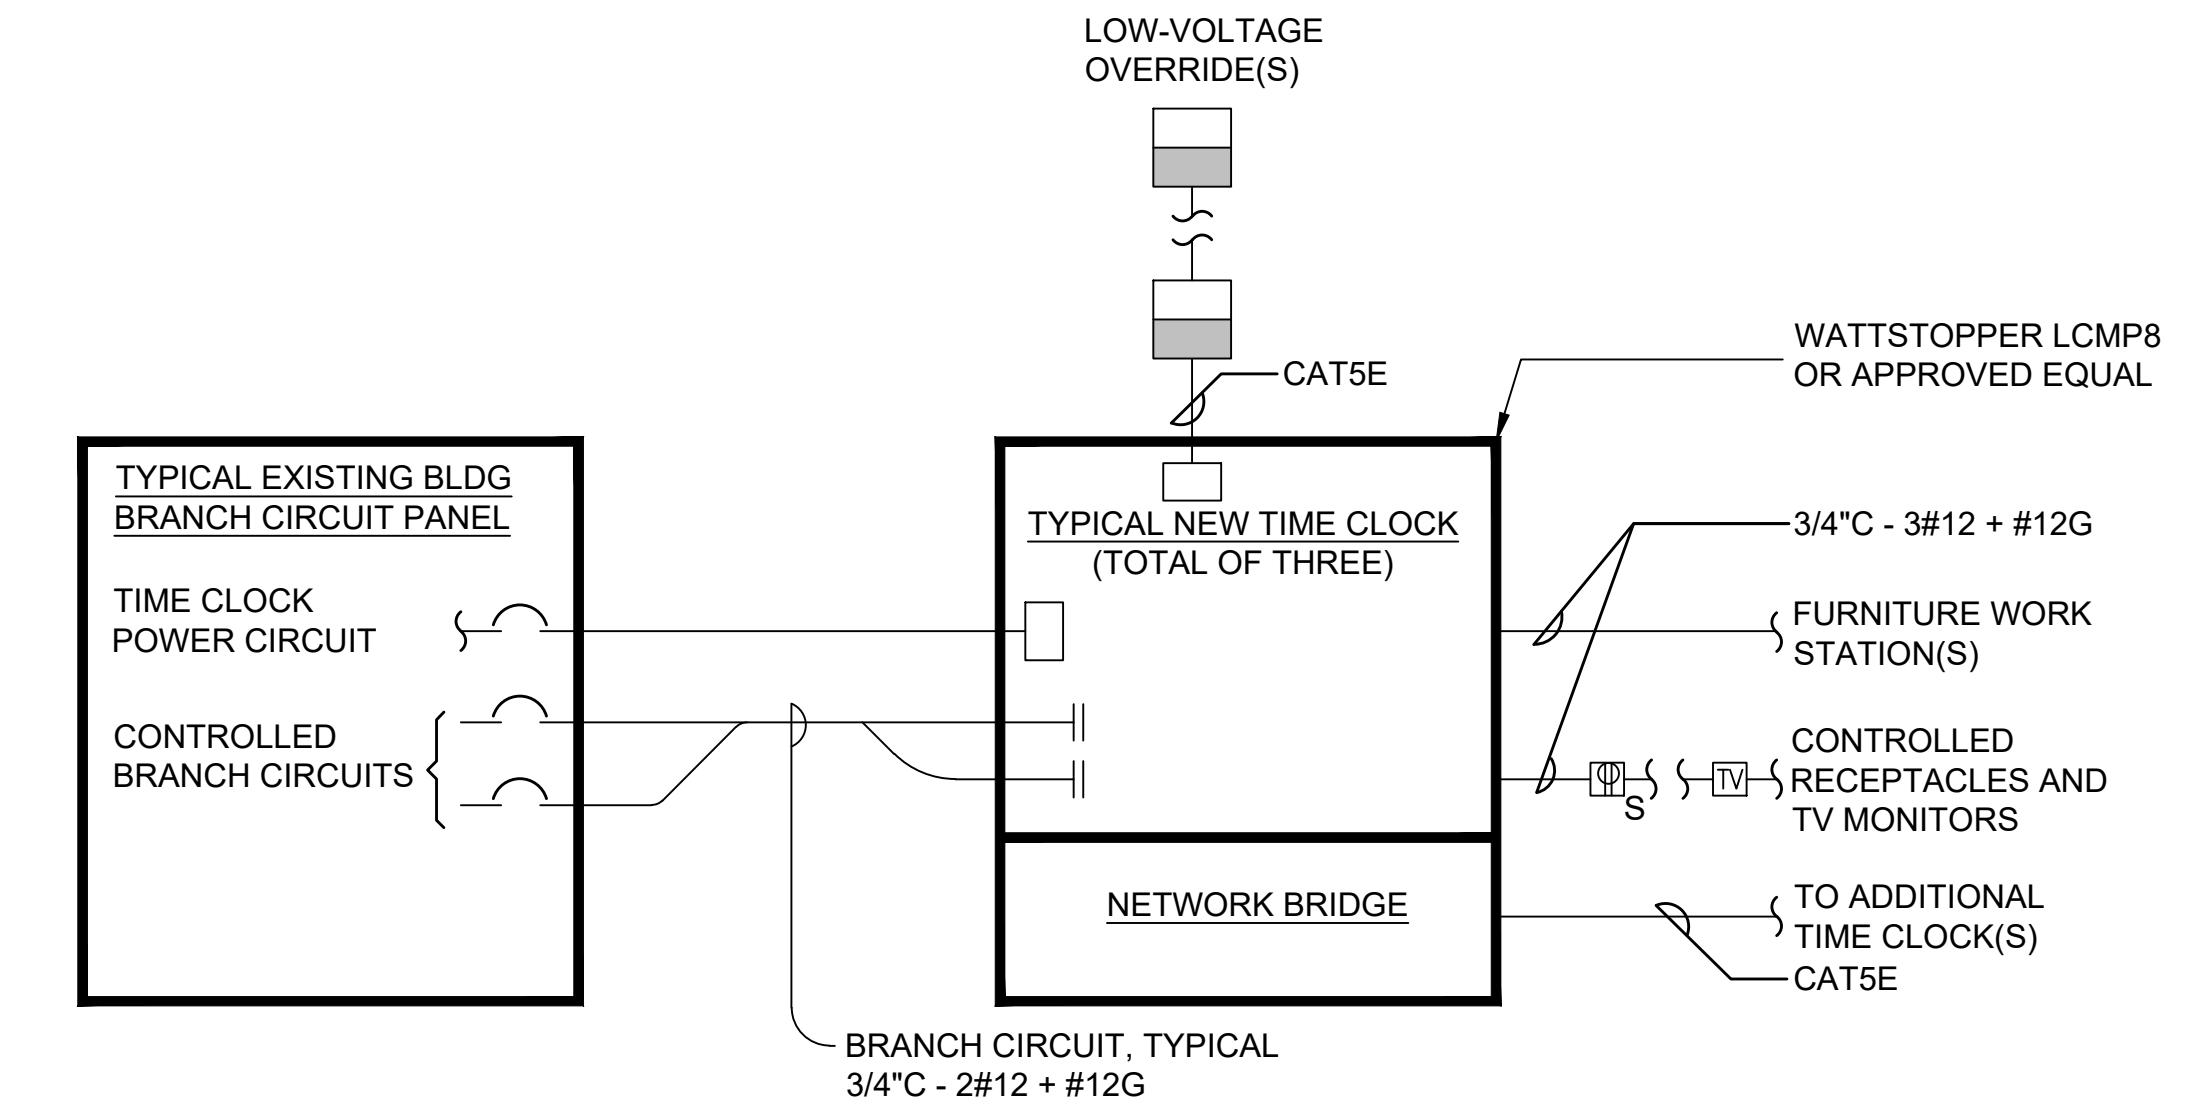


##### NOTES:

1. LOCATE TIME CLOCKS ADJACENT TO BRANCH CIRCUIT PANEL FEEDING THE WORK STATIONS. THERE ARE THREE (3) TIME CLOCKS FOR THIS PROJECT. TC-1, TC-2, TC-3, EACH INSTALLED ADJACENT TO THE RESPECTIVE SOURCE PANELBOARD. ONLY TC-3 IS SHOWN ON THE PLANS. FIELD LOCATE TIME CLOCKS TC-1 AND TC-2 IN THEIR RESPECTIVE ELECTRICAL ROOMS.
2. PROVIDE CONNECTIONS TO FURNITURE WORKSTATIONS PER COORDINATION WITH THE VENDOR AND ASSOCIATED SHOP DRAWINGS. REFER TO CONTROL SEQUENCES FOR ADDITIONAL INFORMATION.
3. PROVIDE INTERCONNECTION BETWEEN TIME CLOCKS FOR OVERRIDE CONTROL COMMUNICATION TO ALL CONTROLLED DEVICES FOR THE PROJECT.
4. NOTED PANELS AND CIRCUITS TO BE DETERMINED IN THE FIELD BY THE CONTRACTOR DURING CONSTRUCTION. REFER TO SHEET E1.2, GENERAL NOTE A. THIS PROJECT INCLUDES BRANCH CIRCUIT INVESTIGATION BY THE CONTRACTOR.
5. SOURCE TIME CLOCK DEPENDS ON BRANCH CIRCUIT USED. FILL IN FINAL INFORMATION FOR OWNER'S DOCUMENTATION UPON COMPLETION OF THE PROJECT AND PRIOR TO DISTRIBUTION OF THE SCHEDULE.
6. AT THE END OF THE PROJECT, PROVIDE A TYPE-WRITTEN SCHEDULE WITH COMPLETE RECEPTACLE CONTROL INFORMATION LOCATED AT THE TIME CLOCKS AND A HARD COPY FOR THE OWNER'S RECORDS.

### ① AUTOMATIC RECEPTACLE CONTROL (TIME CLOCK) INTERCONNECTION DIAGRAM – TYPICAL

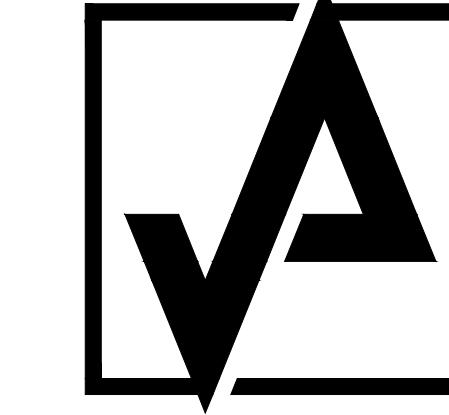

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NUMBER	REMARKS	DATE
1	FOR PERMIT	01-02-2026
2	FOR CONSTRUCTION	01-16-2026
3	OWNER COMMENTS	01-27-2026
4	OWNER COMMENTS	02-02-2026

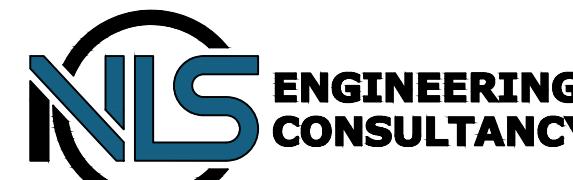

PROJECT TITLE:  
SHEPARD BUILDING  
4TH FLOOR RENOVATION

80 WASHINGTON STREET  
PROVIDENCE, RI 02903  
PROVIDENCE COUNTY

DRAWING TITLE:  
ELECTRICAL SCHEDULES  
AND DETAILS

DATE: 01-27-2026 PROJ NO: 25019.000

DRAWN BY: MR CHECKED BY: JWM

DRAWING NUMBER: E3.1

