

LAVATORY UPGRADES

662 HARTFORD AVE PROVIDENCE, RI


ISSUED: JANUARY 4, 2023

ARCHITECTS:

NORTHEAST COLLABORATIVE ARCHITECTS, LLC 650 Ten Rod Road North Kingstown RI 02852 v: 401.846.9538


MECHANICAL, ELECTRICAL, PLUMBING
ANDRE GILL ENGINEERING
North Smithfield, RI 02896
v: 401.441.3414

REGION MAP (NTS) Woonsocket Attleboro Taunton Warwick Fall River Reserved North Kingstown Newport Narragansett PROJECT LOCATION REGION MAP (NTS) Wannick Attleboro Taunton Warwick Fall River New Bedt North Kingstown Newport Narragansett PLAN NORTH NORTH LOCATION

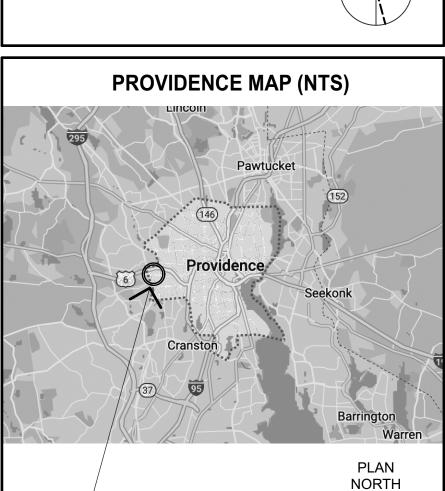


PROJECT

LOCATION

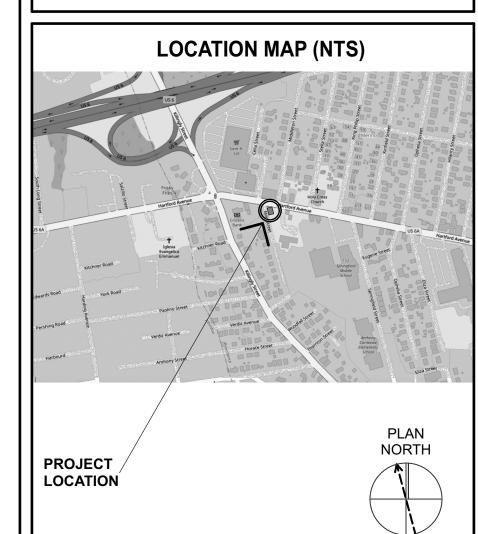

DRAWING LIST

INFO SHEET

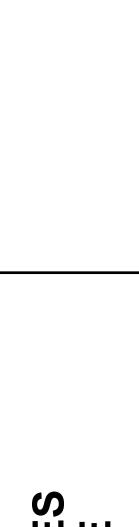

COLLABORATIVE

North Kingstown, RI 02852


ARCHITECTS

650 Ten Rod Road

v: 401.846.9538

LAVATORY UPGRADES 662 HARTFORD AVE PROVIDENCE, RI




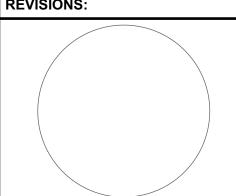


INFO SHEET


A-00	1
NCA JOB NO.:	2307
DATE:	1-04-202

FIXTURE AND ACCESSORY MOUNTING HEIGHTS SHOWER STALL CLEARANCES

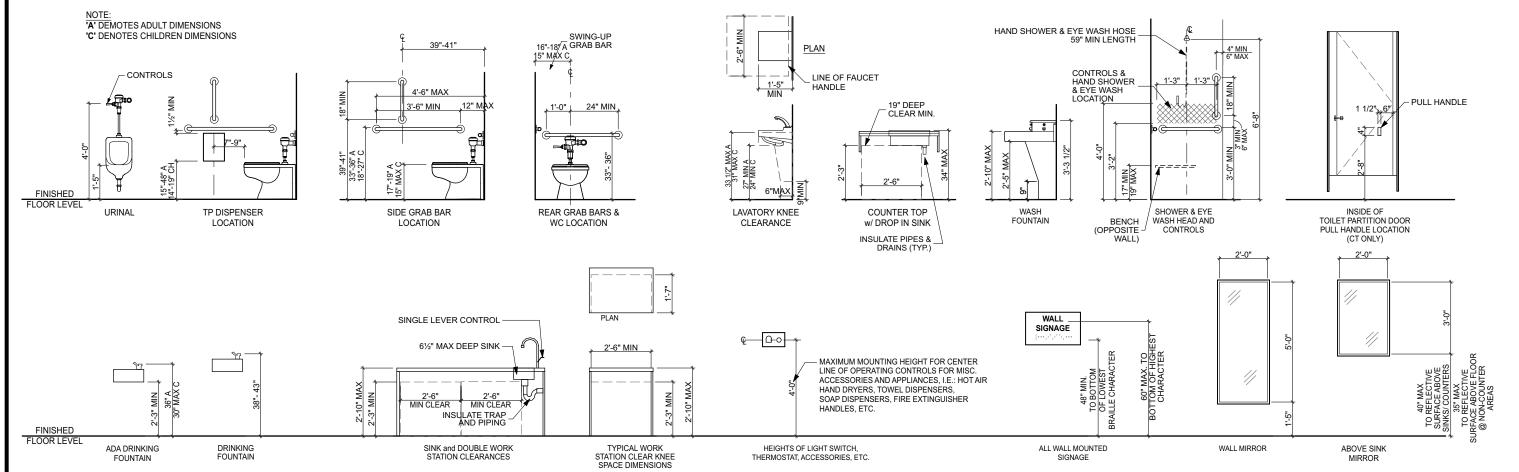

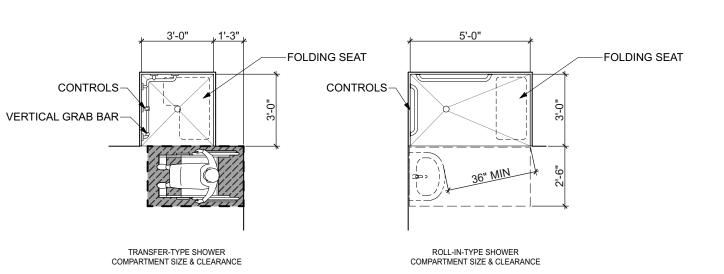


CONSTRUCTION & DEMO PLANS A-112 REFLECTED CEILING & FINISH PLANS A-601 INTERIOR ELEVATIONS A-801 WALL TYPES, DETAILS AND SCHEDULES MECHANICAL GENERAL M3.00 MAIN BATHROOMS M3.01 STAFF BATHROOMS M3.2 MECHANICAL ROOM M5.00 MECHANICAL SCHEDULE PLUMBING GENERAL (D) PLUMBING OVERALL (N) DOMESTIC PLUMBING OVERALL (N) SAN OVERALL PLUMBING P3.00 MAIN BATHROOMS STAFF BATHROOMS P3.01 P3.02 MECHANICAL ROOM P5.00 PLUMBING SCHEDULE PLUMBING SCHEDULE ELECTRICAL GENERAL NOTES, SYMBOLS, ABREVIATIONS **ELECTRICAL DEMOLITION PLAN** ELECTRICAL POWER PLAN E1.01 E5.00 DETAILS

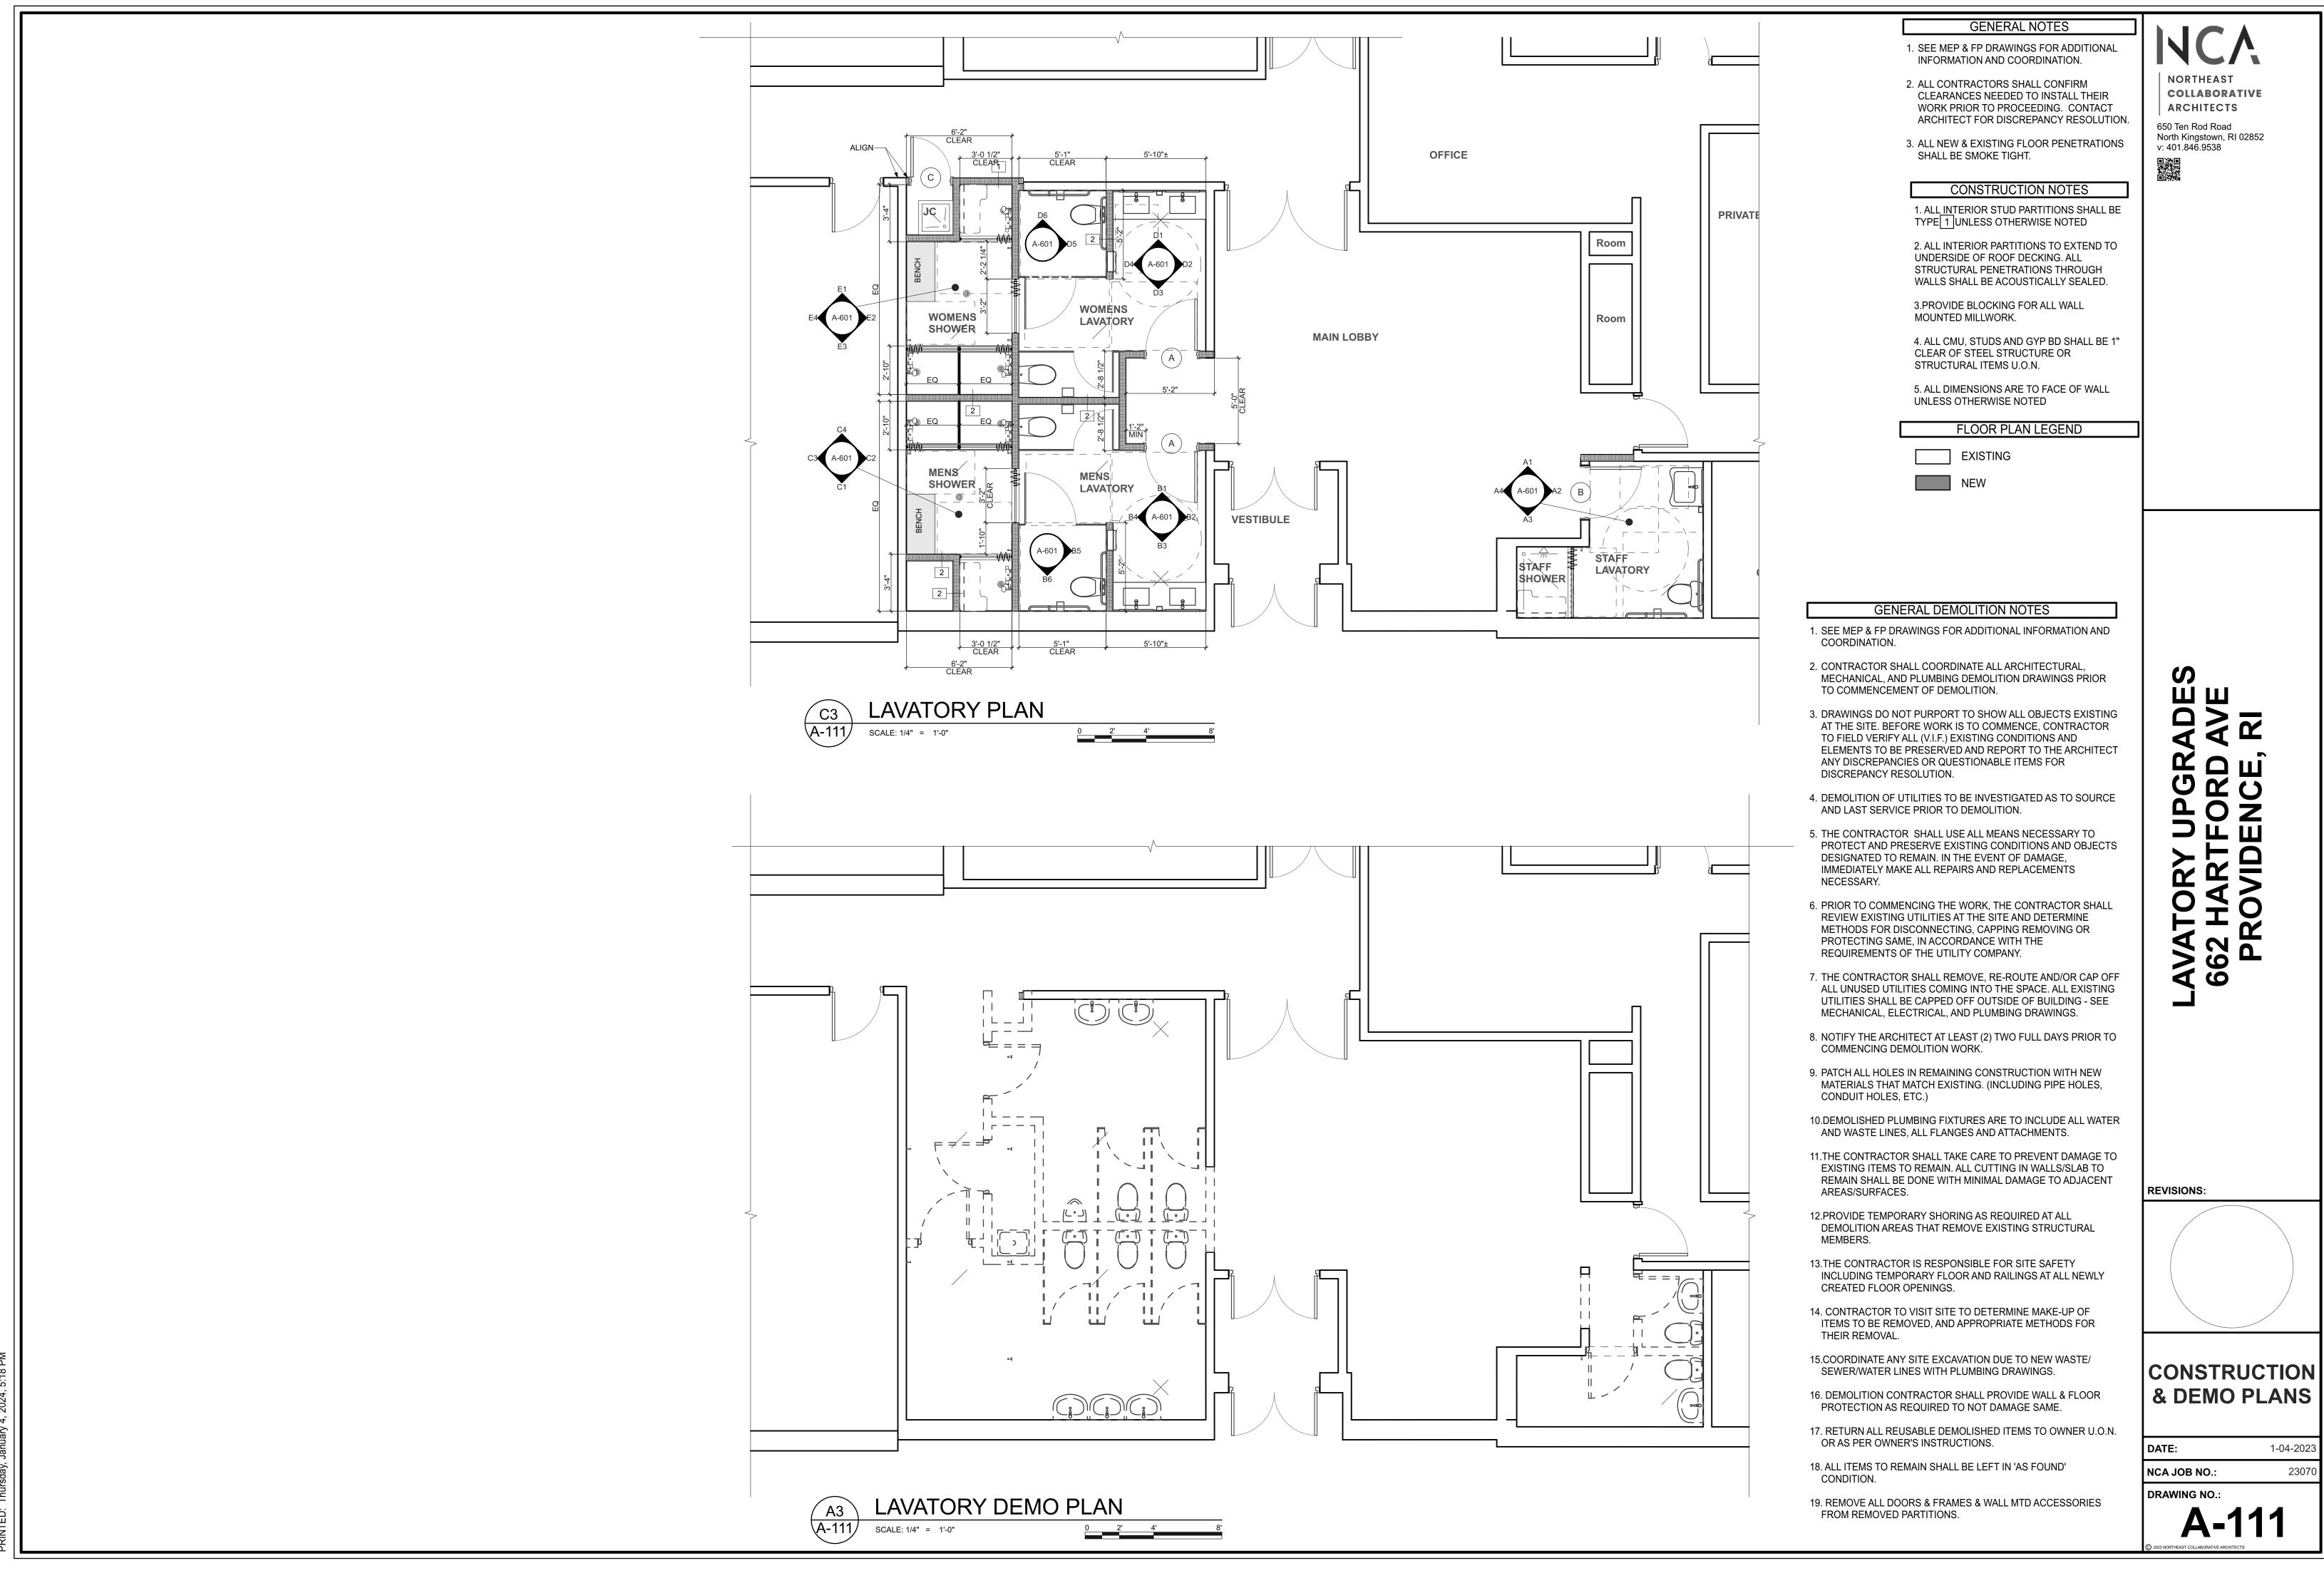

& DEMO PLANS

23070

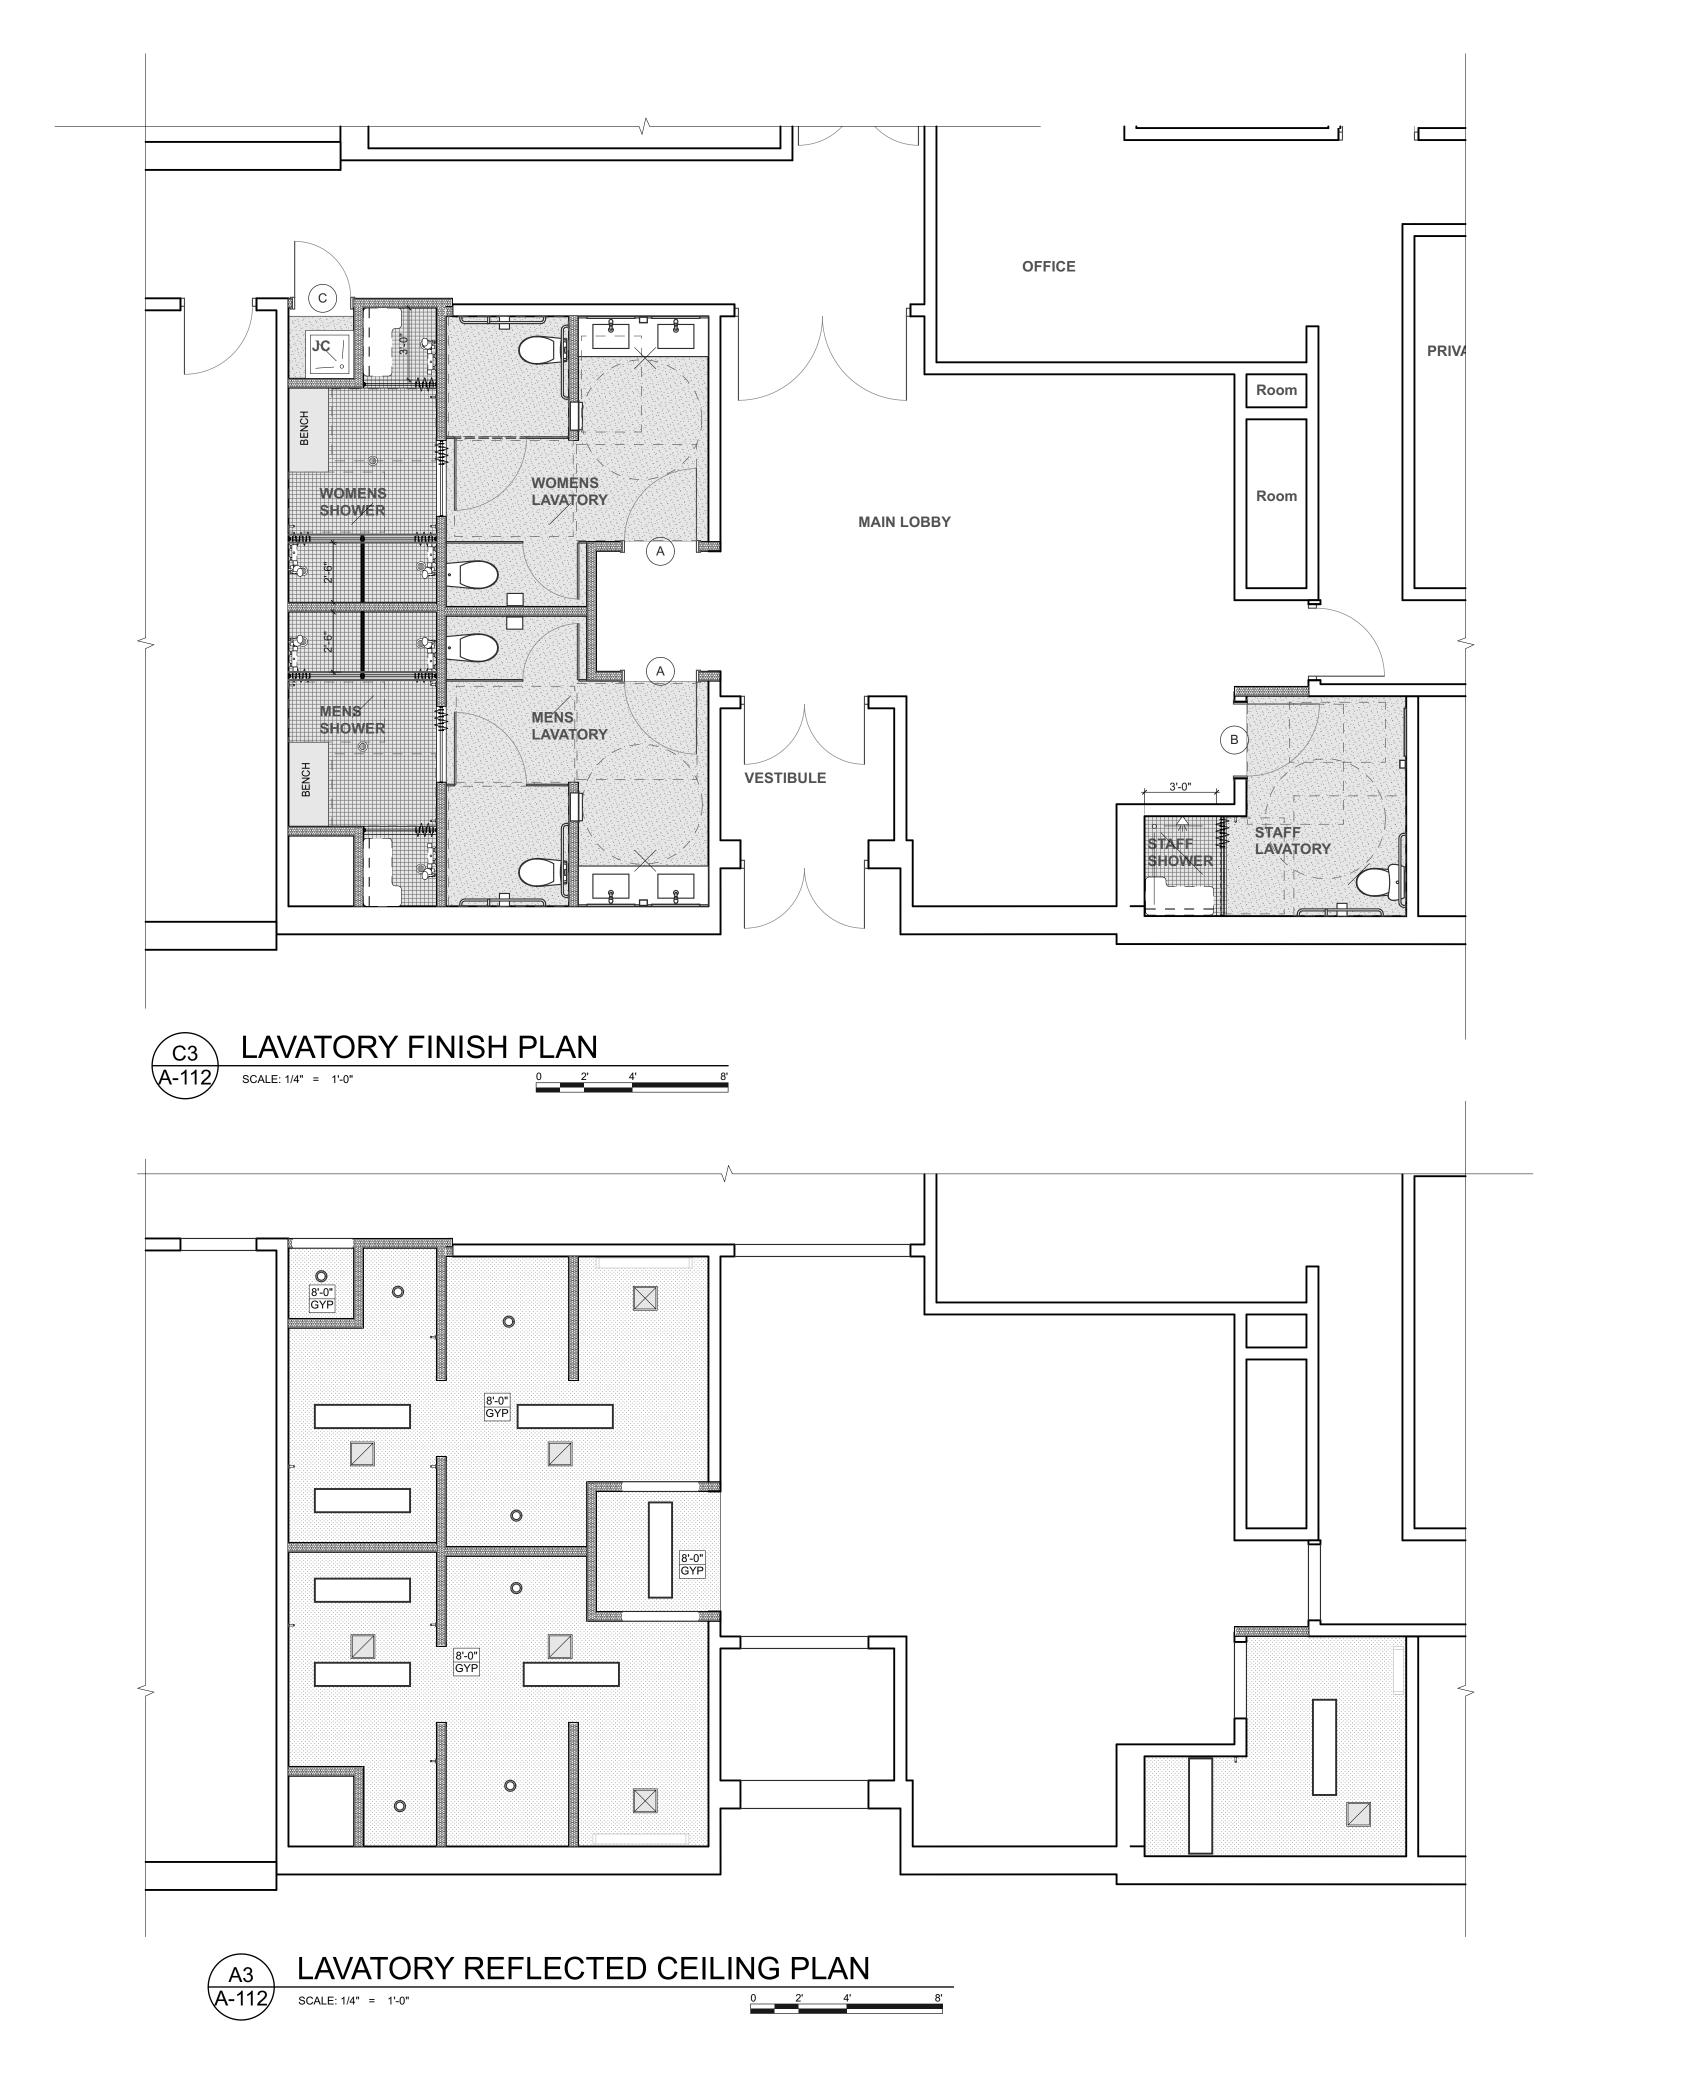

GENERAL NOTES

 SEE MEP & FP DRAWINGS FOR ADDITIONAL INFORMATION AND COORDINATION.

2. ALL CONTRACTORS SHALL CONFIRM CLEARANCES NEEDED TO INSTALL THEIR WORK PRIOR TO PROCEEDING. CONTACT ARCHITECT FOR DISCREPANCY RESOLUTION.

NORTHEAST

ARCHITECTS

North Kingstown, RI 02852 v: 401.846.9538

650 Ten Rod Road

COLLABORATIVE

3. ALL NEW & EXISTING FLOOR PENETRATIONS SHALL BE SMOKE TIGHT.

CONSTRUCTION NOTES

1. ALL INTERIOR STUD PARTITIONS SHALL BE TYPE 1 UNLESS OTHERWISE NOTED

2. ALL INTERIOR PARTITIONS TO EXTEND TO UNDERSIDE OF ROOF DECKING. ALL STRUCTURAL PENETRATIONS THROUGH WALLS SHALL BE ACOUSTICALLY SEALED.

3.PROVIDE BLOCKING FOR ALL WALL MOUNTED MILLWORK.

4. ALL CMU, STUDS AND GYP BD SHALL BE 1" CLEAR OF STEEL STRUCTURE OR STRUCTURAL ITEMS U.O.N.

5. ALL DIMENSIONS ARE TO FACE OF WALL UNLESS OTHERWISE NOTED

REFLECTED CEILING NOTES

1. ALL LIGHT FIXTURES & CEILING GRIDS SHALL BE CENTERED IN ROOMS UON.

- 2. ALL ACP SHALL BE ACP-1 UON.
- CENTER ALL CEILING MOUNTED OBJECTS IN CEILING PANEL/PATTERN UON.
- 4. HANGERS SHALL BE SECURELY ATTACHED TO STRUCTURE ABOVE, WIRE HANGERS SHALL NOT BE LESS THAN 12 GA. AND SHALL BE SADDLE TIED TO MAIN RUNNERS.
- 5. ALL EQUIPMENT ITEMS SHALL BE INDEPENDENTLY SUSPENDED AND NOT CONNECTED TO THE CEILING GRID.
- 6. CEILING SUSPENSION SYSTEM SHALL NOT BE USED TO SUPPORT LIGHT FIXTURES, DUCTWORK, PIPING, ETC.

FLOOR PLAN LEGEND

EXISTING


NEW

REFLECTED CEILING NOTES

- ALL LIGHT FIXTURES & CEILING GRIDS SHALL BE CENTERED IN ROOMS UON.
- 2. ALL ACP SHALL BE ACP-1 UON.
- CENTER ALL CEILING MOUNTED OBJECTS IN CEILING PANEL/PATTERN UON.
- 4. HANGERS SHALL BE SECURELY ATTACHED TO STRUCTURE ABOVE, WIRE HANGERS SHALL NOT BE LESS THAN 12 GA. AND SHALL BE SADDLE TIED TO MAIN RUNNERS.
- 5. ALL EQUIPMENT ITEMS SHALL BE INDEPENDENTLY SUSPENDED AND NOT CONNECTED TO THE CEILING GRID.
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WALL MOUNTED FIXTURE

WALL MOUNTED FIXTURE

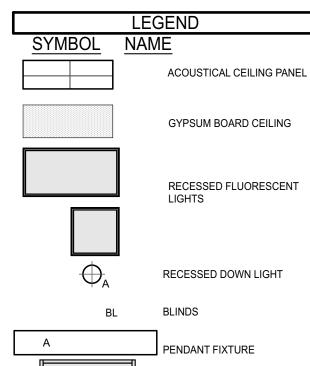


RCP, FINISH PLANS

REVISIONS:


 DATE:
 1-04-2023

 NCA JOB NO.:
 23070

DRAWING NO.:
A-112

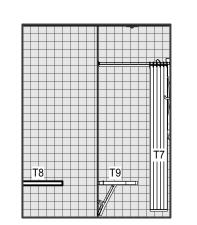




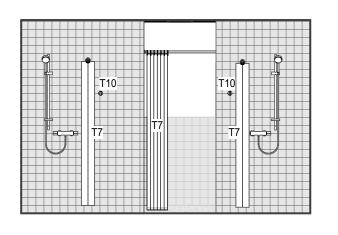


E2 WOMENS SHOWERS

A-601 SCALE: 1/4" = 1'-0"

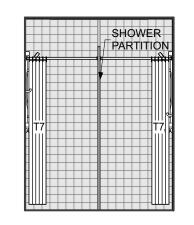

E3 WOMENS SHOWERS
A-601 SCALE: 1/4" = 1'-0"

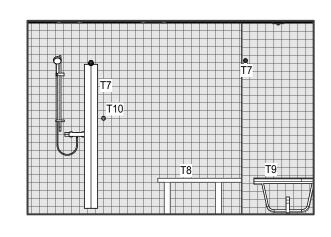


WOMENS SHOWERS

A-601 SCALE: 1/4" = 1'-0"




NOTE: ANCHOR ALL TOILET ACCESSORIES INTO SOLID WOOD BLOCKING.

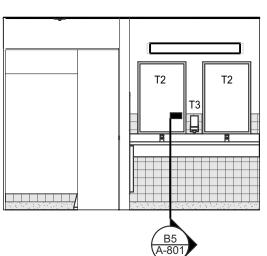


D1 WOMENS LAVATORY

A-601 SCALE: 1/4" = 1'-0"

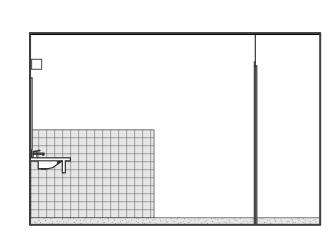


D2 WOMENS LAVATORY

A-601 SCALE: 1/4" = 1'-0"

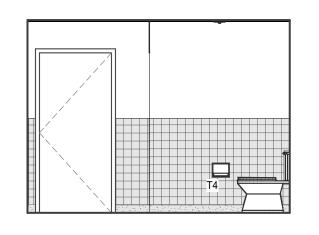


D3 WOMENS LAVATORY

A-601 SCALE: 1/4" = 1'-0"

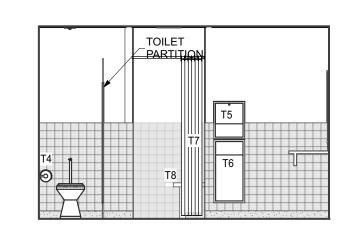


D4 WOMENS LAVATORY
A-601 SCALE: 1/4" = 1'-0"

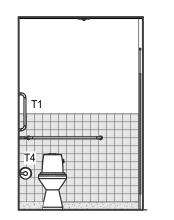

WOMENS


D5 HC TOILET

A-601 SCALE: 1/4" = 1'-0"

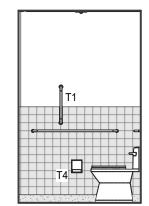


WOMENS
HC TOILET

A-601 SCALE: 1/4" = 1'-0"

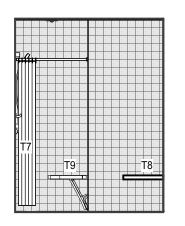


MENS SHOWERS

501 SCALE: 1/4" = 1'-0"

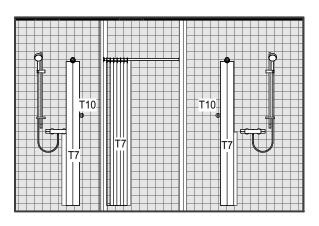


C2 MENS SHOWERS


A-601 SCALE: 1/4" = 1'-0"

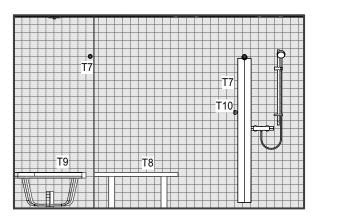


C3 MENS SHOWERS
A-601 SCALE: 1/4" = 1'-0"

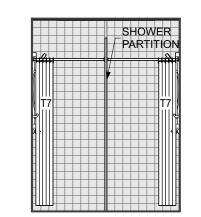




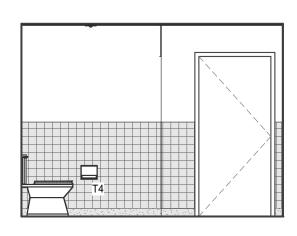


B1 MENS LAVATORY
A-601 SCALE: 1/4" = 1'-0"

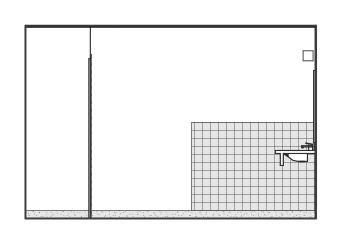

B2 MENS LAVATORY
A-601 SCALE: 1/4" = 1'-0"

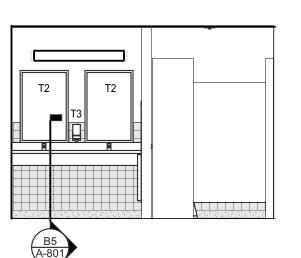


B3 MENS LAVATORY
A-601 SCALE: 1/4" = 1'-0"

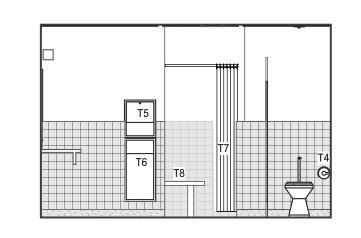


B4 MENS LAVATORY

A-601 SCALE: 1/4" = 1'-0"

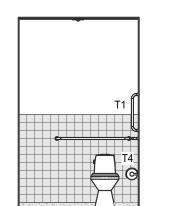


MENS
HC TOILET

A-601 SCALE: 1/4" = 1'-0"

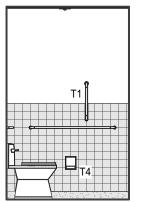


MENS
HC TOILET


A-601 SCALE: 1/4" = 1'-0"

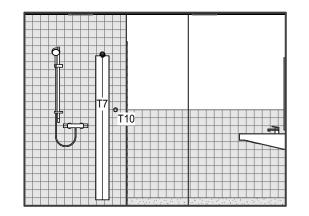


A1 STAFF LAVATORY
A-601 SCALE: 1/4" = 1'-0"

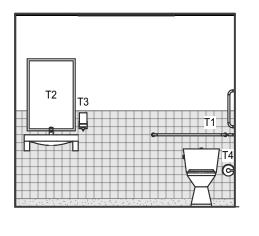


A2 STAFF LAVATORY
A-601 SCALE: 1/4" = 1'-0"

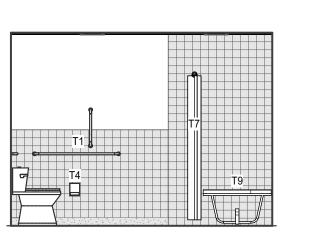

A3 STAFF LAVATORY
A-601 SCALE: 1/4" = 1'-0"

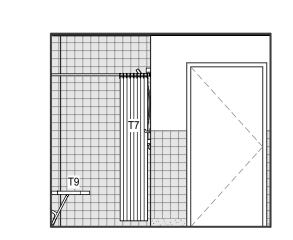

A4 STAFF LAVATORY
A-601 SCALE: 1/4" = 1'-0"

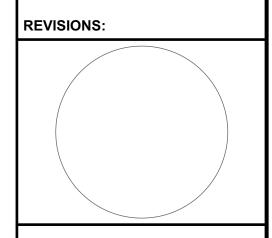

NORTHEAST

ARCHITECTS


650 Ten Rod Road


COLLABORATIVE

North Kingstown, RI 02852 v: 401.846.9538

INTERIOR ELEVATIONS

DATE:	1-04-2023	
NCA JOB NO.:	23070	
DRAWING NO.:		

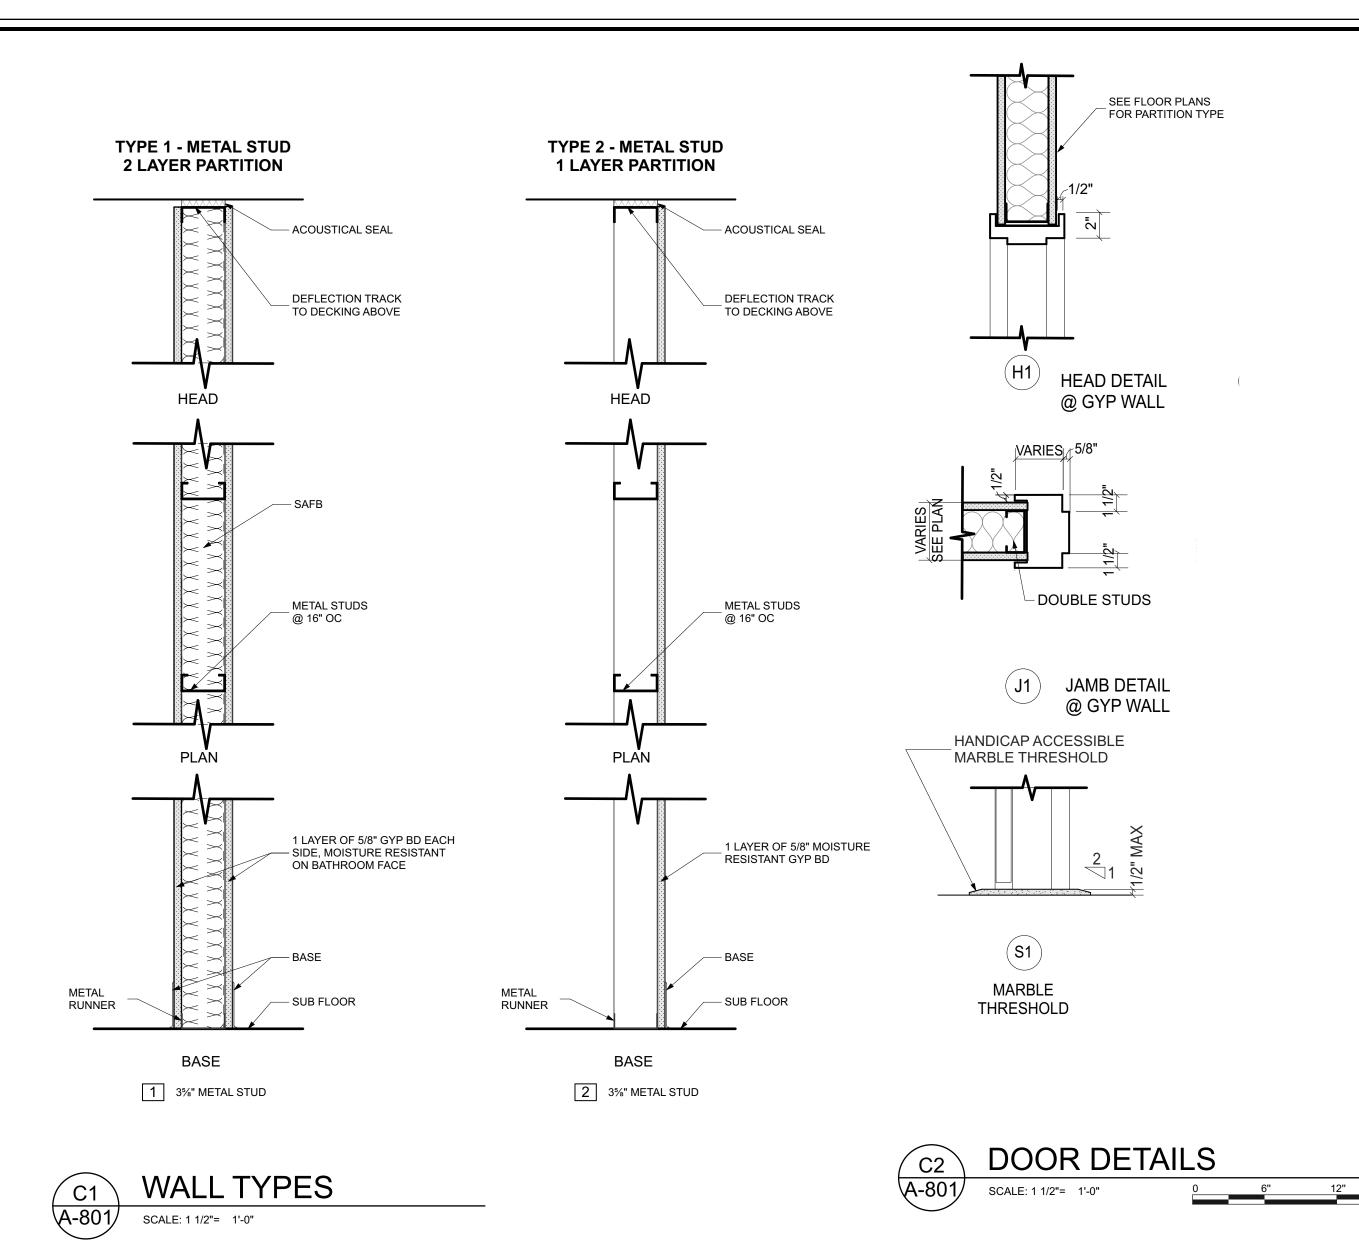

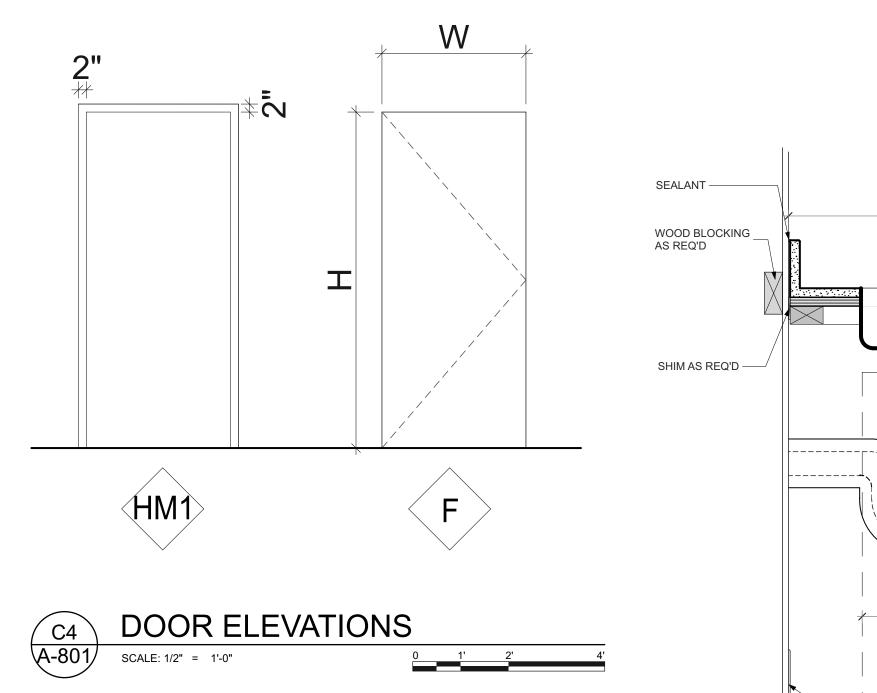

	DOOR SCHEDULE																					
DOOR NUMBE	R				DOOR					FRAME			HARDWARE									
DOOM II		STATUS	STATUS	STATUS	ID STATUS	STATUS	STATUS	STATUS	STATUS	NOMINAL	NOMINAL	LEAF	MATERIAL	F1 F1/	NAATEDIAL	ELEV	DETAIL				SIGNAGE	NOTES
ROOM	טו	WIDTH HEIGHT THICKNES		THICKNESS	MATERIAL ELEV		MATERIAL	HEAD		JAMB	SADDLE	SET										
WOMEN'S LAVATORY	Α	NEW	3'-0"	7'-0"	1 3/4"	WOOD	F	HM	HM1	H1	J1	S1	1	WOMEN'S LAVATORY	PAINT FRAME							
MEN'S LAVATORY	А	NEW	3'-0"	7'-0"	1 3/4"	WOOD	F	HM	HM1	H1	J1	S1	1	MEN'S LAVATORY	PAINT FRAME							
STAFF LAVATORY	В	NEW	3'-0"	7'-0"	1 3/4"	WOOD	F	HM	HM1	H1	J1	S1	2	LAVATORY	PAINT FRAME							
JANITOR'S CLOSET	С	NEW	2'-4"	7'-0"	1 3/4"	WOOD	F	HM	HM1	H1	J1		3	JANITORS' CLOSET	PAINT FRAME							

								FINISH SCHE	DULE					
	Fl	LOOR	BASE		WALLS									
ROOM NAME	CLIDCTDATE	SUBSTRATE FINISH MATERIAL	DCTD ATE FINISH MATERIAL			NORTH		EAST		SOUTH		WEST	SUBSTRATE	FINISH MATERIAL
	SUBSTRATE		FINISH MATERIAL	SUBSTRATE	FINISH MATERIAL	SUBSTRATE	FINISH MATERIAL	SUBSTRATE	FINISH MATERIAL	SUBSTRATE	FINISH MATERIAL	SUBSTRATE	FINISH WATERIAL	
WOMEN'S LAVATORY	CONC.	EPOXY	TILE	MR GYP	PAINT, 4" x 4" TILE BOTTOM 4'	MR GYP	PAINT, 4" x 4" TILE BOTTOM 4'	MR GYP	PAINT, 4" x 4" TILE BOTTOM 4'	MR GYP	PAINT, 4" x 4" TILE BOTTOM 4'	MR GYP	PAINT	
WOMEN'S SHOWER	CONC.	2"x 2" TILE	-	MR GYP	TILE	MR GYP	TILE	MR GYP	TILE	MR GYP	TILE	MR GYP	PAINT	
MEN'S LAVATORY	CONC.	EPOXY	TILE	MR GYP	PAINT, 4" x 4" TILE BOTTOM 4'	MR GYP	PAINT, 4" x 4" TILE BOTTOM 4'	MR GYP	PAINT, 4" x 4" TILE BOTTOM 4'	MR GYP	PAINT, 4" x 4" TILE BOTTOM 4'	MR GYP	PAINT	
MEN'S SHOWER	CONC.	2"x 2" TILE	-	MR GYP	TILE	MR GYP	TILE	MR GYP	TILE	MR GYP	TILE	MR GYP	PAINT	
STAFF LAVATORY	CONC.	EPOXY	TILE	MR GYP	PAINT, 4" x 4" TILE BOTTOM 4'	MR GYP	PAINT, 4" x 4" TILE BOTTOM 4'	MR GYP	PAINT, 4" x 4" TILE BOTTOM 4'	MR GYP	PAINT, 4" x 4" TILE BOTTOM 4'	MR GYP	PAINT	
STAFF SHOWER	CONC.	2"x 2" TILE	-	MR GYP	PAINT, 4" x 4" TILE BOTTOM 4'			MR GYP	4" x 4" TILE	MR GYP	4" x 4" TILE	MR GYP	PAINT	
JANITOR'S CLOSET	CONC.	EPOXY	TILE	MR GYP	PAINT	MR GYP	PAINT	MR GYP	PAINT	MR GYP	PAINT	MR GYP	PAINT	



-AVATORY UPGRADES 662 HARTFORD AVE PROVIDENCE. RI

SOLID SURFACE W/ EASED EDGE

SOLID SURFACE

19" CLR


ACCESSIBLE SINK DETAIL

— TILE FLOOR

@ ACCESSIBLE SINK

DEMOIONG

DATE:

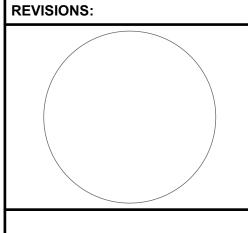

WALL TYPES, MILLWORK & SCHEDULES

NCA JOB NO.: 23070

DRAWING NO.:

A-801

1-04-2023

GENERAL NOTES: SYMBOLS GENERAL SYMBOLS: 1. THE FOLLOWING GENERAL NOTES APPLY TO ELECTRICAL DRAWINGS. DASHED SYMBOL INDICATES EXISTING FIXTURE, DEVICE, OUTLET OR EQUIPMENT TO REMAIN. 2. INSTALLATION OF ELECTRICAL MATERIAL SHALL CONFORM WITH LOCAL REGULATIONS AND THE 2022 NATIONAL ELECTRICAL CODE (CEC), RHODE ISLAND BUILIDNG CODE, AND OTHER \square \diamondsuit \$ SOLID SYMBOL INDICATES NEW FIXTURE, DEVICE, OUTLET. GOVERNING CODES AND ORDINANCES. DASHED SYMBOL WITH HATCH INDICATES FIXTURE, DEVICE, 3. ELECTRICAL EQUIPMENT SHALL BE NRTL LABELED. OUTLET OR EQUIPMENT TO BE DEMOLISHED. 4. THE CONTRACTOR SHALL VISIT THE SITE INCLUDING AREAS INDICATED ON THE DRAWINGS. THE KEY NOTE REFERENCE CONTRACTOR SHALL THOROUGHLY FAMILIARIZE HIMSELF WITH THE EXISTING CONDITIONS AND BY DETAIL NUMBER DESIGNATION. SUBMITTING A BID ACCEPTS CONDITIONS UNDER WHICH THE CONTRACTOR SHALL BE REQUIRED TO PERFORM THE WORK. SHEET DETAIL REFERENCED ON. 5. THE CONTRACTOR SHALL COORDINATE HIS WORK WITH OTHER TRADES AT THE SITE. IT SHALL DETAIL OR SECTION REFERENCES IN NOTES. BE THE ELECTRICAL CONTRACTOR'S RESPONSIBILITY TO OBTAIN A COMPLETE SET OF DRAWINGS AND SPECIFICATIONS. THE CONTRACTOR SHALL CHECK THE DRAWINGS OF THE OTHER TRADES INDICATES MOUNTING HEIGHT ABOVE FINISHED FLOOR. AND SHALL CAREFULLY READ THE ENTIRE SPECIFICATIONS AND DETERMINE RESPONSIBILITIES. FAILURE TO DO SO SHALL NOT RELEASE THE CONTRACTOR FROM DOING THE WORK IN RACEWAY SYSTEMS COMPLETE ACCORDANCE WITH THE DRAWINGS AND SPECIFICATIONS. HOMERUN TO PANELBOARD "A" - CIRCUITS 1. FEEDER OR CIRCUIT NUMBERS AS NOTED. UNLESS OTHERWISE INDICATED, 2#12 AWG (CU) & #12G. THE CONTRACTOR SHALL SECURE AND PAY FOR PERMITS AND FEES NECESSARY FOR LARGE LINE THROUGH ARROW REPRESENTS GROUNDED CONDUCTOR (NEUTRAL). EXECUTION AND COMPLETION OF ELECTRICAL WORK, INCLUDING CHARGES BY THE LOCAL SMALL LINE THROUGH ARROW REPRESENTS PHASE CONDUCTOR, DOT REPRESENTS GOVERNMENT AGENCIES. EQUIPMENT GROUNDING CONDUCTOR. IF TWO LARGE LINES ARE SHOWN, THERE ARE TWO (2) PHASE CONDUCTORS AND TWO NUMBERS WILL BE GIVEN (A-1,3) 7. THE CONTRACTOR SHALL COORDINATE HIS WORK WITH OTHER TRADES AT THE SITE. COSTS TO ROUTE CONDUIT OTHER THAN AS SHOWN ON THE PLANS SHALL BE INCURRED BY THE HOMERUN TO PANELBOARD "A" - CIRCUITS 1 & 3 & 5. FEEDER OR CIRCUIT CONTRACTOR. NUMBERS AS NOTED. CONDUIT AND CONDUCTORS PROVIDED AS INDICATED (1/2" A - 1, 3, 5CONDUIT, 3 - #8AWG CURRENT CARRYING CONDUCTORS #10AWG EQUIPMENT 8. WHEREVER A DISCREPANCY IN QUANTITY OR SIZE OF CONDUIT, WIRE, EQUIPMENT DEVICES, 1/2"C,3#8,#10G GROUNDING CONDUCTOR) CIRCUIT BREAKERS, TRANSFORMERS, GROUND FAULT PROTECTION SYSTEM, ETC. (MATERIALS, ARISES ON THE DRAWINGS AND/OR SPECIFICATIONS), THE CONTRACTOR SHALL BE RESPONSIBLE OUTLETS AND RECEPTACLES FOR PROVIDING AND INSTALLING MATERIAL AND SERVICES REQUIRED BY THE STRICTEST SUBSCRIPT ADJACENT TO OUTLET INDICATES: CONDITIONS NOTED ON DRAWINGS AND/OR IN THE SPECIFICATIONS TO ENSURE COMPLETE AND "GFCI" = GROUND FAULT CIRCUIT INTERRUPTER, PERSONAL PROTECTION. OPERABLE SYSTEMS AS REQUIRED BY THE OWNER OR ENGINEER. "+XX" = DIMENSIONED HEIGHT. DUPLEX CONVENIENCE RECEPTACLE 20A, 125V. WALL MOUNTED DEVICE AT 18" 9. CONDUIT SIZES ARE BASED ON COPPER CONDUCTORS WITH THHN/THWN-2 INSULATION UNLESS SURFACE AFF UON. OTHERWISE NOTED. CONDUCTORS SHALL BE COPPER. CONDUCTOR INSULATION SHALL BE FLUSH THHN/THWN-2 UNLESS OTHERWISE NOTED. QUAD CONVENIENCE RECEPTACLE 20A, 125V. WALL MOUNTED DEVICE AT 18" AFF 10. CONDUIT RUNS SHOWN ARE DIAGRAMMATIC ONLY. INSTALL CONDUITS TO SUIT FIELD SPECIAL RECEPTACLE OUTLET WITH NEMA CONFIGURATION NUMBER AS NOTED, AT CONDITIONS. +16" AFF UON. 11. INSTALL EQUIPMENT, DEVICES, CONDUIT AND CONDUIT SUPPORTS TO MEET SEISMIC CATEGORY "D" REQUIREMENTS. MANUAL ON BUTTON AND/OR DMMER MOUNTED AT +48"UON. LOWERCASE LETTER 12. PROVIDE PROPERLY SIZED LUGS AT CIRCUIT BREAKER PANELS, FOR THE CONDUCTORS SHOWN INDICATES ZONE WHEN APPLIED. UPPER CASE "D" REPRESENTS DIMMER. WHEN TO CONNECT TO THESE LUGS. MULTIPLE LETTERS SHOWN. LIGHT CONTAINS A DIMMER AND/OR MANUAL ON BUTTON FOR EACH ZONE INDICATED. 13. INSTALL EXTERIOR MOUNTED ELECTRICAL EQUIPMENT IN WEATHERPROOF, NEMA 3R ENCLOSURES. Sys Wall Mounted Vacancy sensor with Manual on Button. Mounted at 48". 14. SEPARATE INSULATED EQUIPMENT GROUNDING CONDUCTOR, SIZED PER NEC TABLE 250.122, UON. OS INDICATES OCCUPANCY SENSOR. SHALL BE PROVIDED, INSTALLED IN THE SAME CONDUIT AS THE CIRCUIT CONDUCTORS, FOR FEEDER AND BRANCH CIRCUITS. LIGHT FIXTURE. UPPER CASE LETTER INDICATES FIXTURE TYPE, LOWER CASE B LETTER INDICATES LIGHTING ZONE (WHEN APPLIED), PANEL # INDICATES SOURCE 15. THE CONTRACTOR SHALL SUPPLY POWER TO AND MAKE CONNECTION TO MOTORS AND PANEL - # CIRCUIT WHEN APPLIED. EQUIPMENT REQUIRING ELECTRICAL, INCLUDING FRACTIONAL HORSEPOWER MOTORS. IT SHALL BE THE RESPONSIBILITY OF THE CONTRACTOR TO REVIEW THE MECHANICAL AND PLUMBING PANEL – # DRAWINGS FOR DUCTS, LINES AND EQUIPMENT. ■ CEILING MOUNTED LED EXIT SIGN WITH GREEN LETTERING AND NICKEL CADMIUM BATTERY BACK UP, SHADED SIDE INDICATE LIT SIDE, ARROW INDICATES DIRECTION 17. EXACT METHOD AND LOCATION OF CONDUIT PENETRATIONS AND/OR OPENINGS IN CONCRETE WHEN PRESENT WALLS OR FLOORS SHALL BE AS DIRECTED BY A STRUCTURAL ENGINEER. **▶** WALL MOUNTED LED EXIT SIGN, SAME ATTRIBUTES AS ABOVE CEILING MOUNTED EXIT SIGN. 19. COMPLY WITH NFPA 70E. 20. INTERRUPTION OF EXISTING ELECTRIC SERVICE: DO NOT INTERRUPT ELECTRIC SERVICE TO DUAL TECHNOLOGY (INFRARED AND ULTRASONIC) VACANCY/OCCUPANCY SENSOR FACILITIES OCCUPIED BY OWNER OR OTHER UNLESS PERMITTED UNDER TO FOLLOWING CEILING MOUNTED CONDITIONS AND THEN ONLY AFTER ARRANGING TO PROVIDE TEMPORARY ELECTRIC SERVICE PHOTOCELL ACCORDING TO REQUIREMENTS INDICATED: A. NOTIFY OWNER NO FEWER THAN THIRTY DAYS IN ADVANCE OF PROPOSED INTERRUPTION D OF ELECTRIC SERVICE. **ADA CONTROLS** B. NOTIFY OWNER, IN WRITING, FOURTEEN DAYS IN ADVANCE OF THE REQUIRED OUTAGE IF ADA DOOR PUSHBUTTON THE SCHEDULE FOR PERFORMING WORK HAS CHANGED OR IF REVISIONS TO THE OUTAGE PLAN ARE REQUIRED. C. SHUTDOWNS ARE TO OCCUR ON NON-SCHOOL HOURS OR NON-SCHOOL DAYS ONLY D. INDICATE METHOD OF PROVIDING TEMPORARY ELECTRIC SERVICE IF SERVICE CAN NOT BE DISCONNECT AND OVERCURRENT DEVICES RESTORED WITHIN DESIRED TIME. CIRCUIT BREAKER SAFETY SWITCHES THE CONTRACTOR SHALL PROVIDE AND KEEP UP-TO-DATE A COMPLETE RECORD SET OF NUMBERS OF POLES NUMBERS OF POLES DRAWINGS. THESE PRINTS SHALL BE CORRECTED DAILY AND SHOW EVERY CHANGE * FROM THE ORIGINAL DRAWINGS. THIS SET OF DRAWINGS SHALL BE KEPT ON THE TRIP (AMPERES) FUSE SIZE (AMPS) 100 JOB SITE AND SHALL BE USED ONLY AS A RECORD SET. THIS SHALL NOT BE FRAME (AMPERES) RATING (AMPERES) CONSTRUED AS AUTHORIZATION FOR THE CONTRACTOR TO MAKE CHANGES IN THE 10 I.C. (1000 AMPS) FUSE CLASS (UL) LAYOUT WITHOUT DEFINITE INSTRUCTIONS IN EACH CASE. UPON COMPLETION OF THE WORK, A SET OF REPRODUCIBLE CONTRACT DRAWINGS SHALL BE OBTAINED FROM * "NA" INDICATES NON-AUTOMATIC C/B THE OWNER, AND CHANGES AS NOTED ON THE RECORD SET OF DRAWINGS SHALL INDICATES NON-FUSED SWITCH * "NF" BE INCORPORATED THEREON WITH BLACK INK IN A NEAT, LEGIBLE, UNDERSTANDABLE * "50" INDICATES TRIP OR FUSE SIZE AND PROFESSIONAL MANNER. * "**" INDICATES FUSE SIZE PER MANUFACTURER'S RECOMMENDATION 21. ENSURE ADA DOOR OPENERS ARE PROVIDED WITH INTEGRAL DISCONNECT SWITCH COMPLIANT WITH NEC 422.34 STAMP CONSULTANTS MEP ENGINEER: ARCHITECT: FIRE PROTECTION:

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ABBREVIATIONS: SYMBOLS MISCELLANEOUS AMPERE A OR AMP ABOVE COUNTER TOP DISCONNECT SWITCH WHEN ON POWER PLANS, MOUNTED AT +48"UON. AMP FUSE (FOR FUSED SWITCHES) AMP FRAME (FOR CIRCUIT BREAKERS) JUNCTION OR OUTLET BOX. CEILING OR WALL MOUNTED AS INDICATED. LOCATE ARC-FLASH CIRCUIT INTERRUPTER ABOVE ACCESSIBLE CEILINGS UON. AMPS INTERRUPTING CAPACITY PANELBOARD. FLUSH AMP TRIP BARE COPPER GROUND FUSED SAFETY DISCONNECT SWITCH CONDUIT CIRCUIT BREAKER NON-FUSED SAFETY DISCONNECT SWITCH CALIFORNIA ELECTRIC CODE CIRCUIT MOTOR STARTER SWITCH. CONTINUED CWP COLD WATER PIPE TRANSFORMER DIAMETER POWER DISCONNECT DISTRIBUTION EQUIPMENT, TYPICALLY EQUIPMENT WITH A MOTOR. **EQUIP** EQUIPMENT FINISHED FLOOR SINGLE LINE DIAGRAM: FOOT, FEET G, GND GROUND SPLICE/TERMINAL GFI, GFCI GROUND FAULT CIRCUIT INTERRUPTER GROUNDING ELECTRODE HORSE POWER KAIC THOUSAND AMPERE INTERRUPT CURRENT THOUSAND CIRCULAR MILS KCMIL GROUND BUS OR TERMINALS KILA-VOLT-AMP (POWER) KVA KILOWATT(S) SHORT CIRCUIT CURRENT, AMPS MANUFACTURER COLD WATER PIPE NATIONAL ELECTRICAL CODE NOT TO SCALE PHASE GROUND ROD POLYVINYL CHLORIDE RIGID METAL CONDUIT REFERENCE REQUIRED **TVSS** TRANSIENT VOLTAGE SURGE SUPPRESSOR TYP TYPICAL UNLESS OTHERWISE NOTED THREE WIRE VOLT WATER HEATER WEATHERPROOF

CALLOUT	SYMBOL	DESCRIPTION	MODEL	INPUT WATTS	QUANTITY
R4		LED 1x4 RECESSED FIXTURE, 1500 Nominal Lumens, 80CRI, 3500K CCT	Lithonia Lighting, EPANL 1X4 1500LM 80CRI 35K	13.96	4
R4E		LED 1x4 RECESSED FIXTURE, 1500 Nominal Lumens, 80CRI, 3500K CCT WITH EMERGENCY BATTERY	Lithonia Lighting, EPANL 1X4 1500LM 80CRI 35K E10WCP	13.96	6
RD	0	4" Ultra-Thin LED Wafer Downlight, 3500K CCT, 120V	Lithonia Lighting, WF4 LED 35K	10.1	6
W2		LINEAR LED WALL SCONCE SYMMETRIC 24"	VISA LIGHTING, CV1800	6.4	1
W 5		LINEAR LED WALL SCONCE SYMMETRIC 60"	VISA LIGHTING, CV1806	22.8	2





АС	Project Title: DA BATHROOM UPGRA	Project Number 2355	
	Location: 662 HARTFORD AVE PROVIDENCE, RI 0290	Drawing Scale As Indicated	
ELECTRICAL GEN	Drawing Title: IERAL NOTES, SYMBOL	Drawing Number E 0.01	
Issue Date:	Approved By:	Drawn By:	Checked By:
12/02/23	AGE	MO	MO

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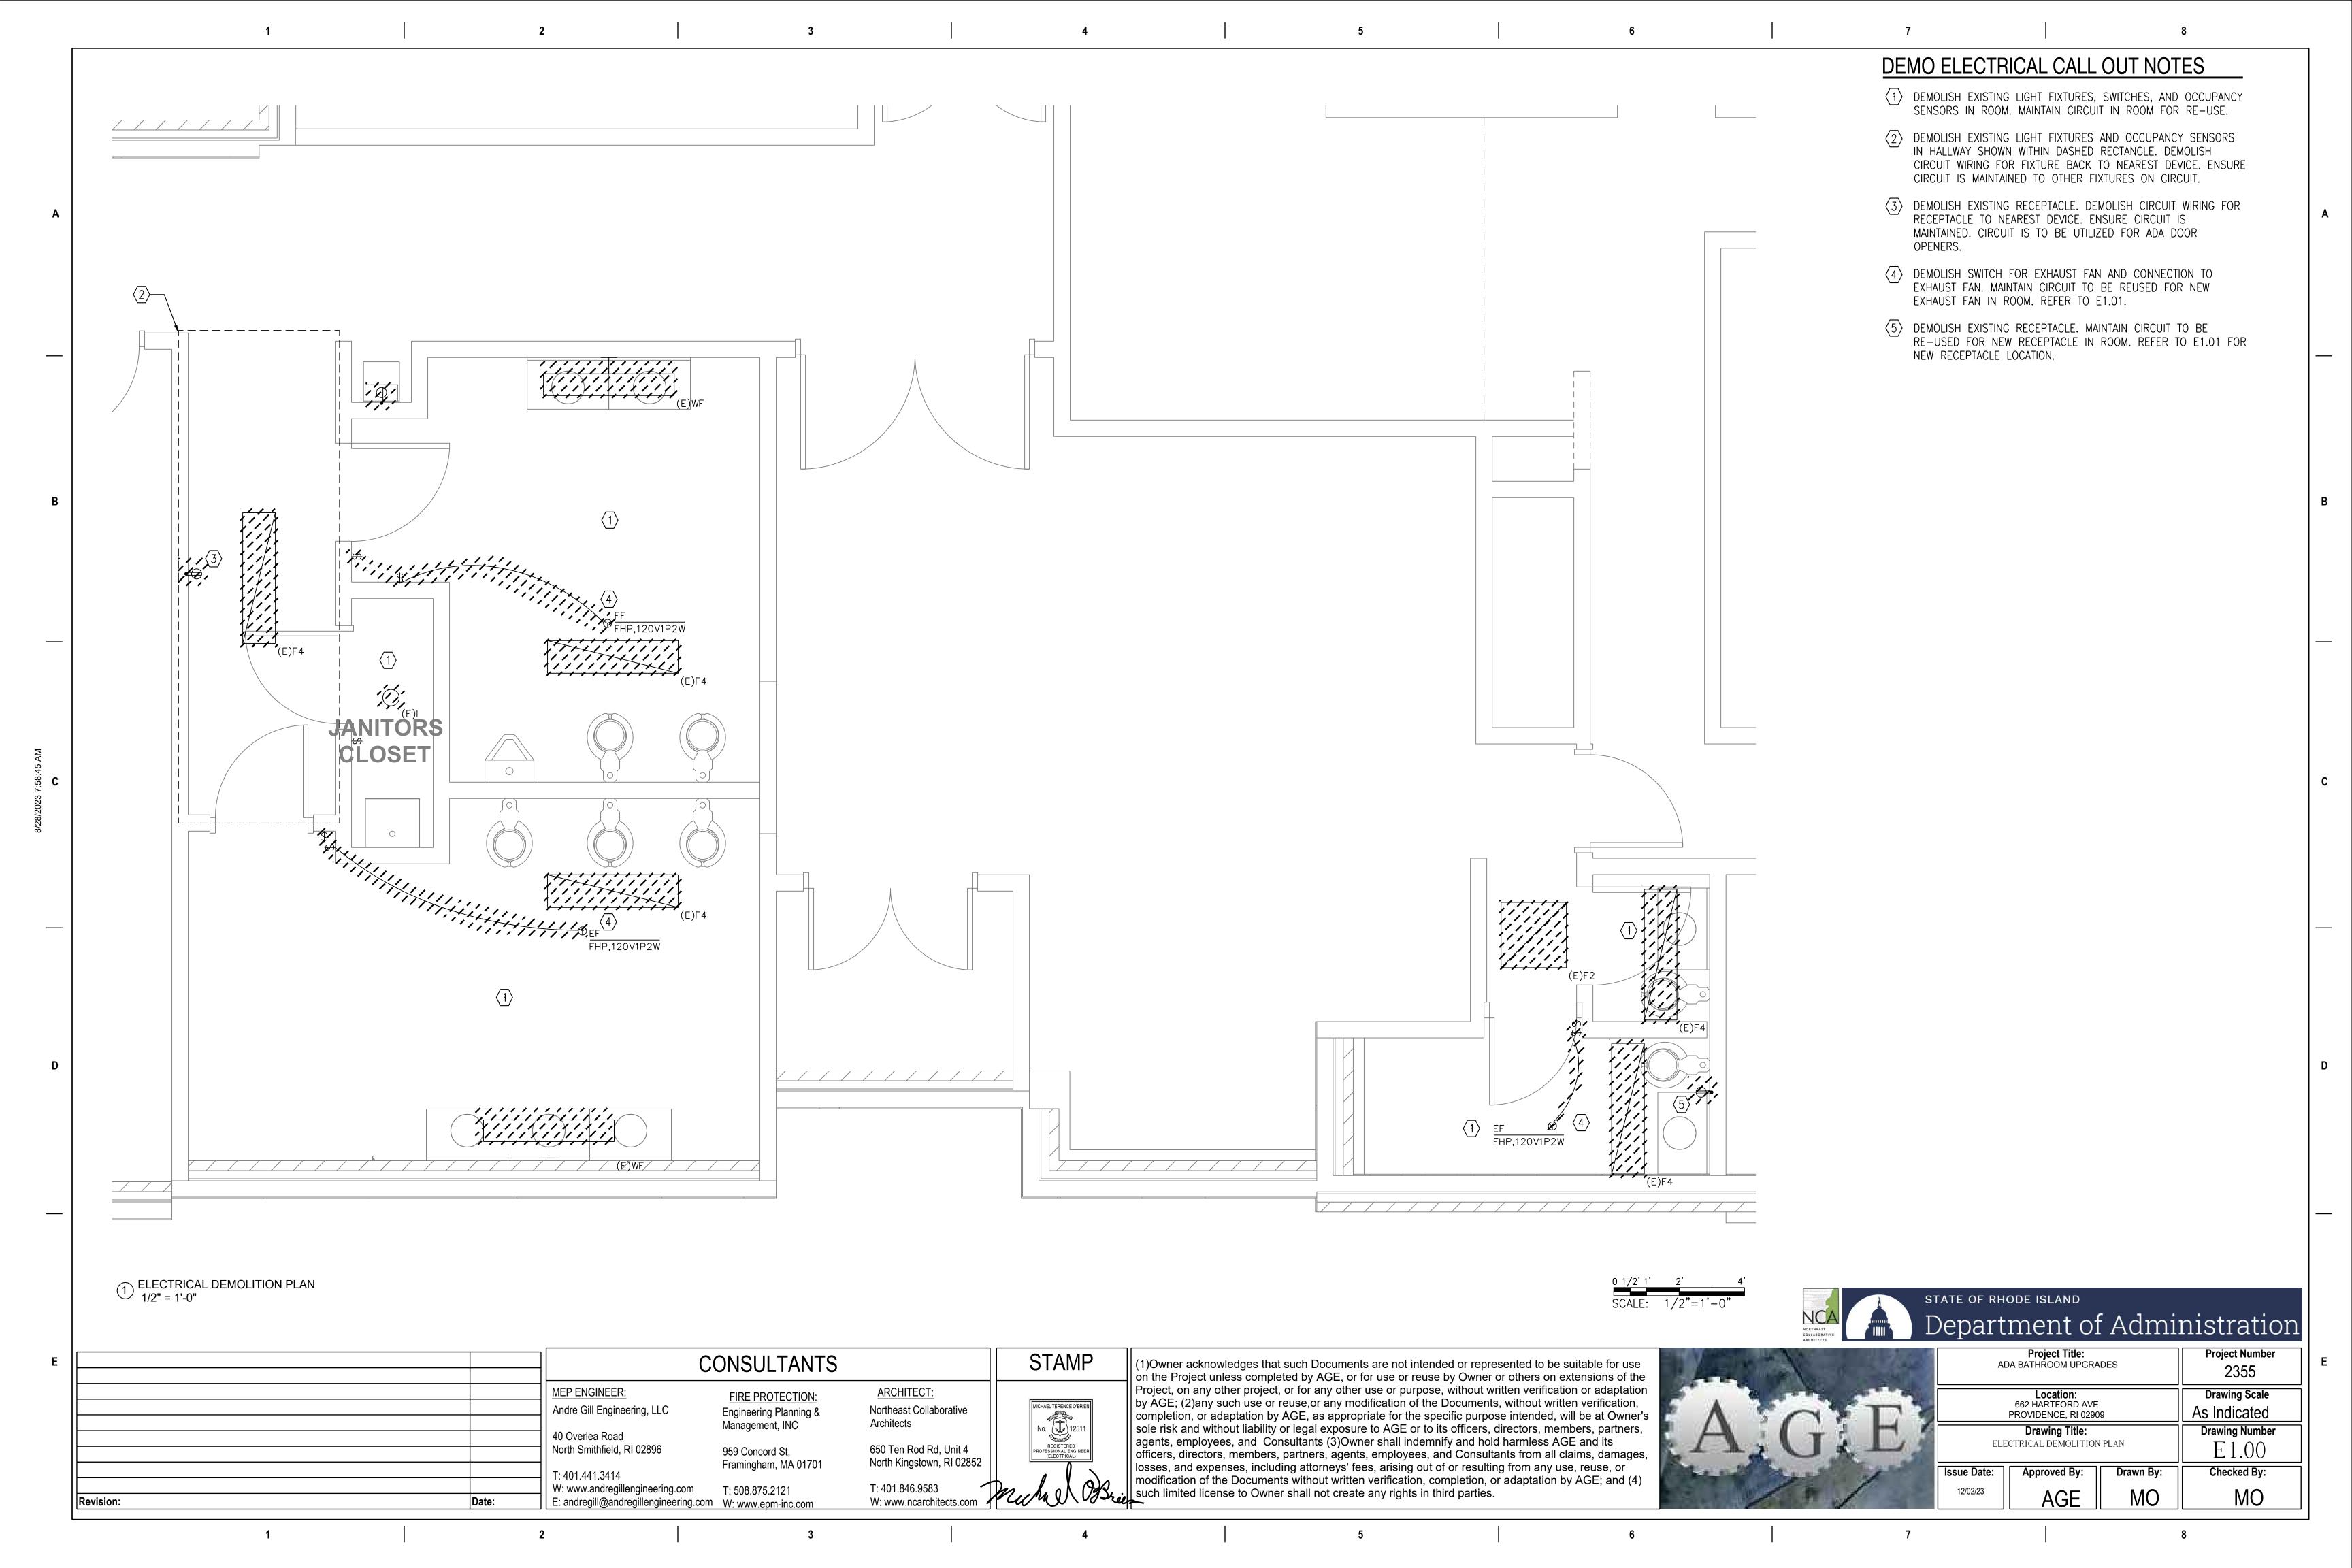
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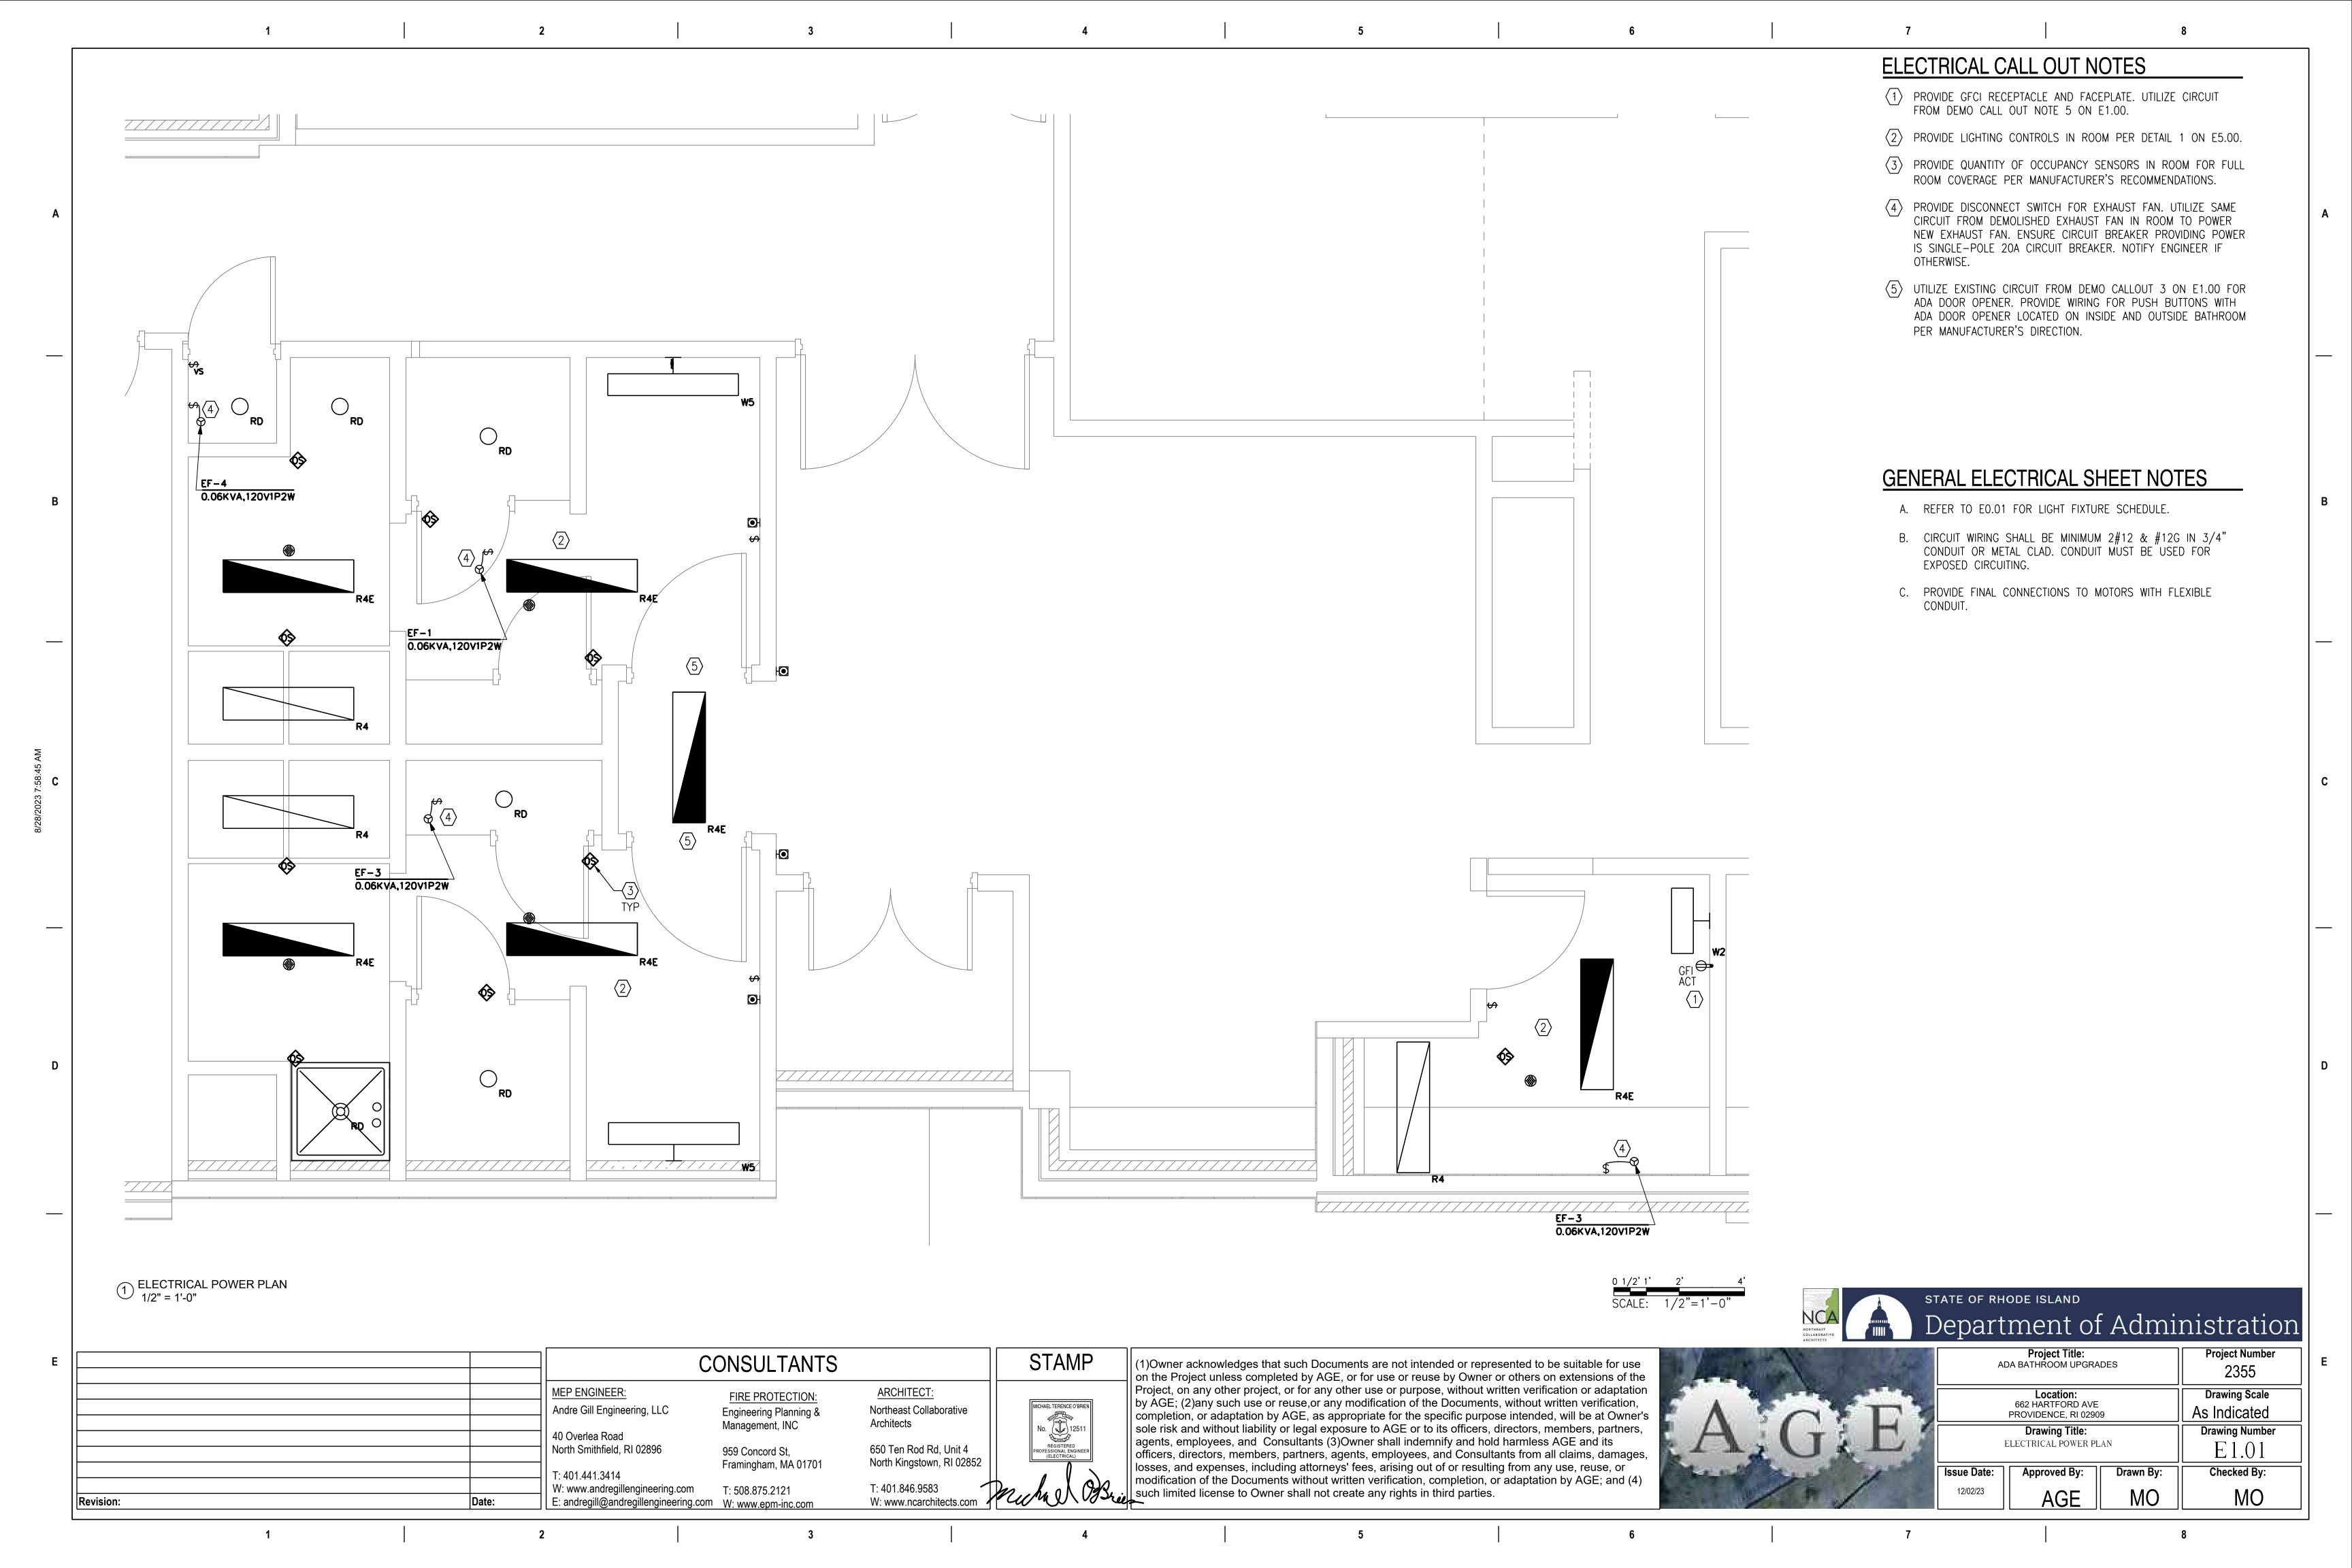
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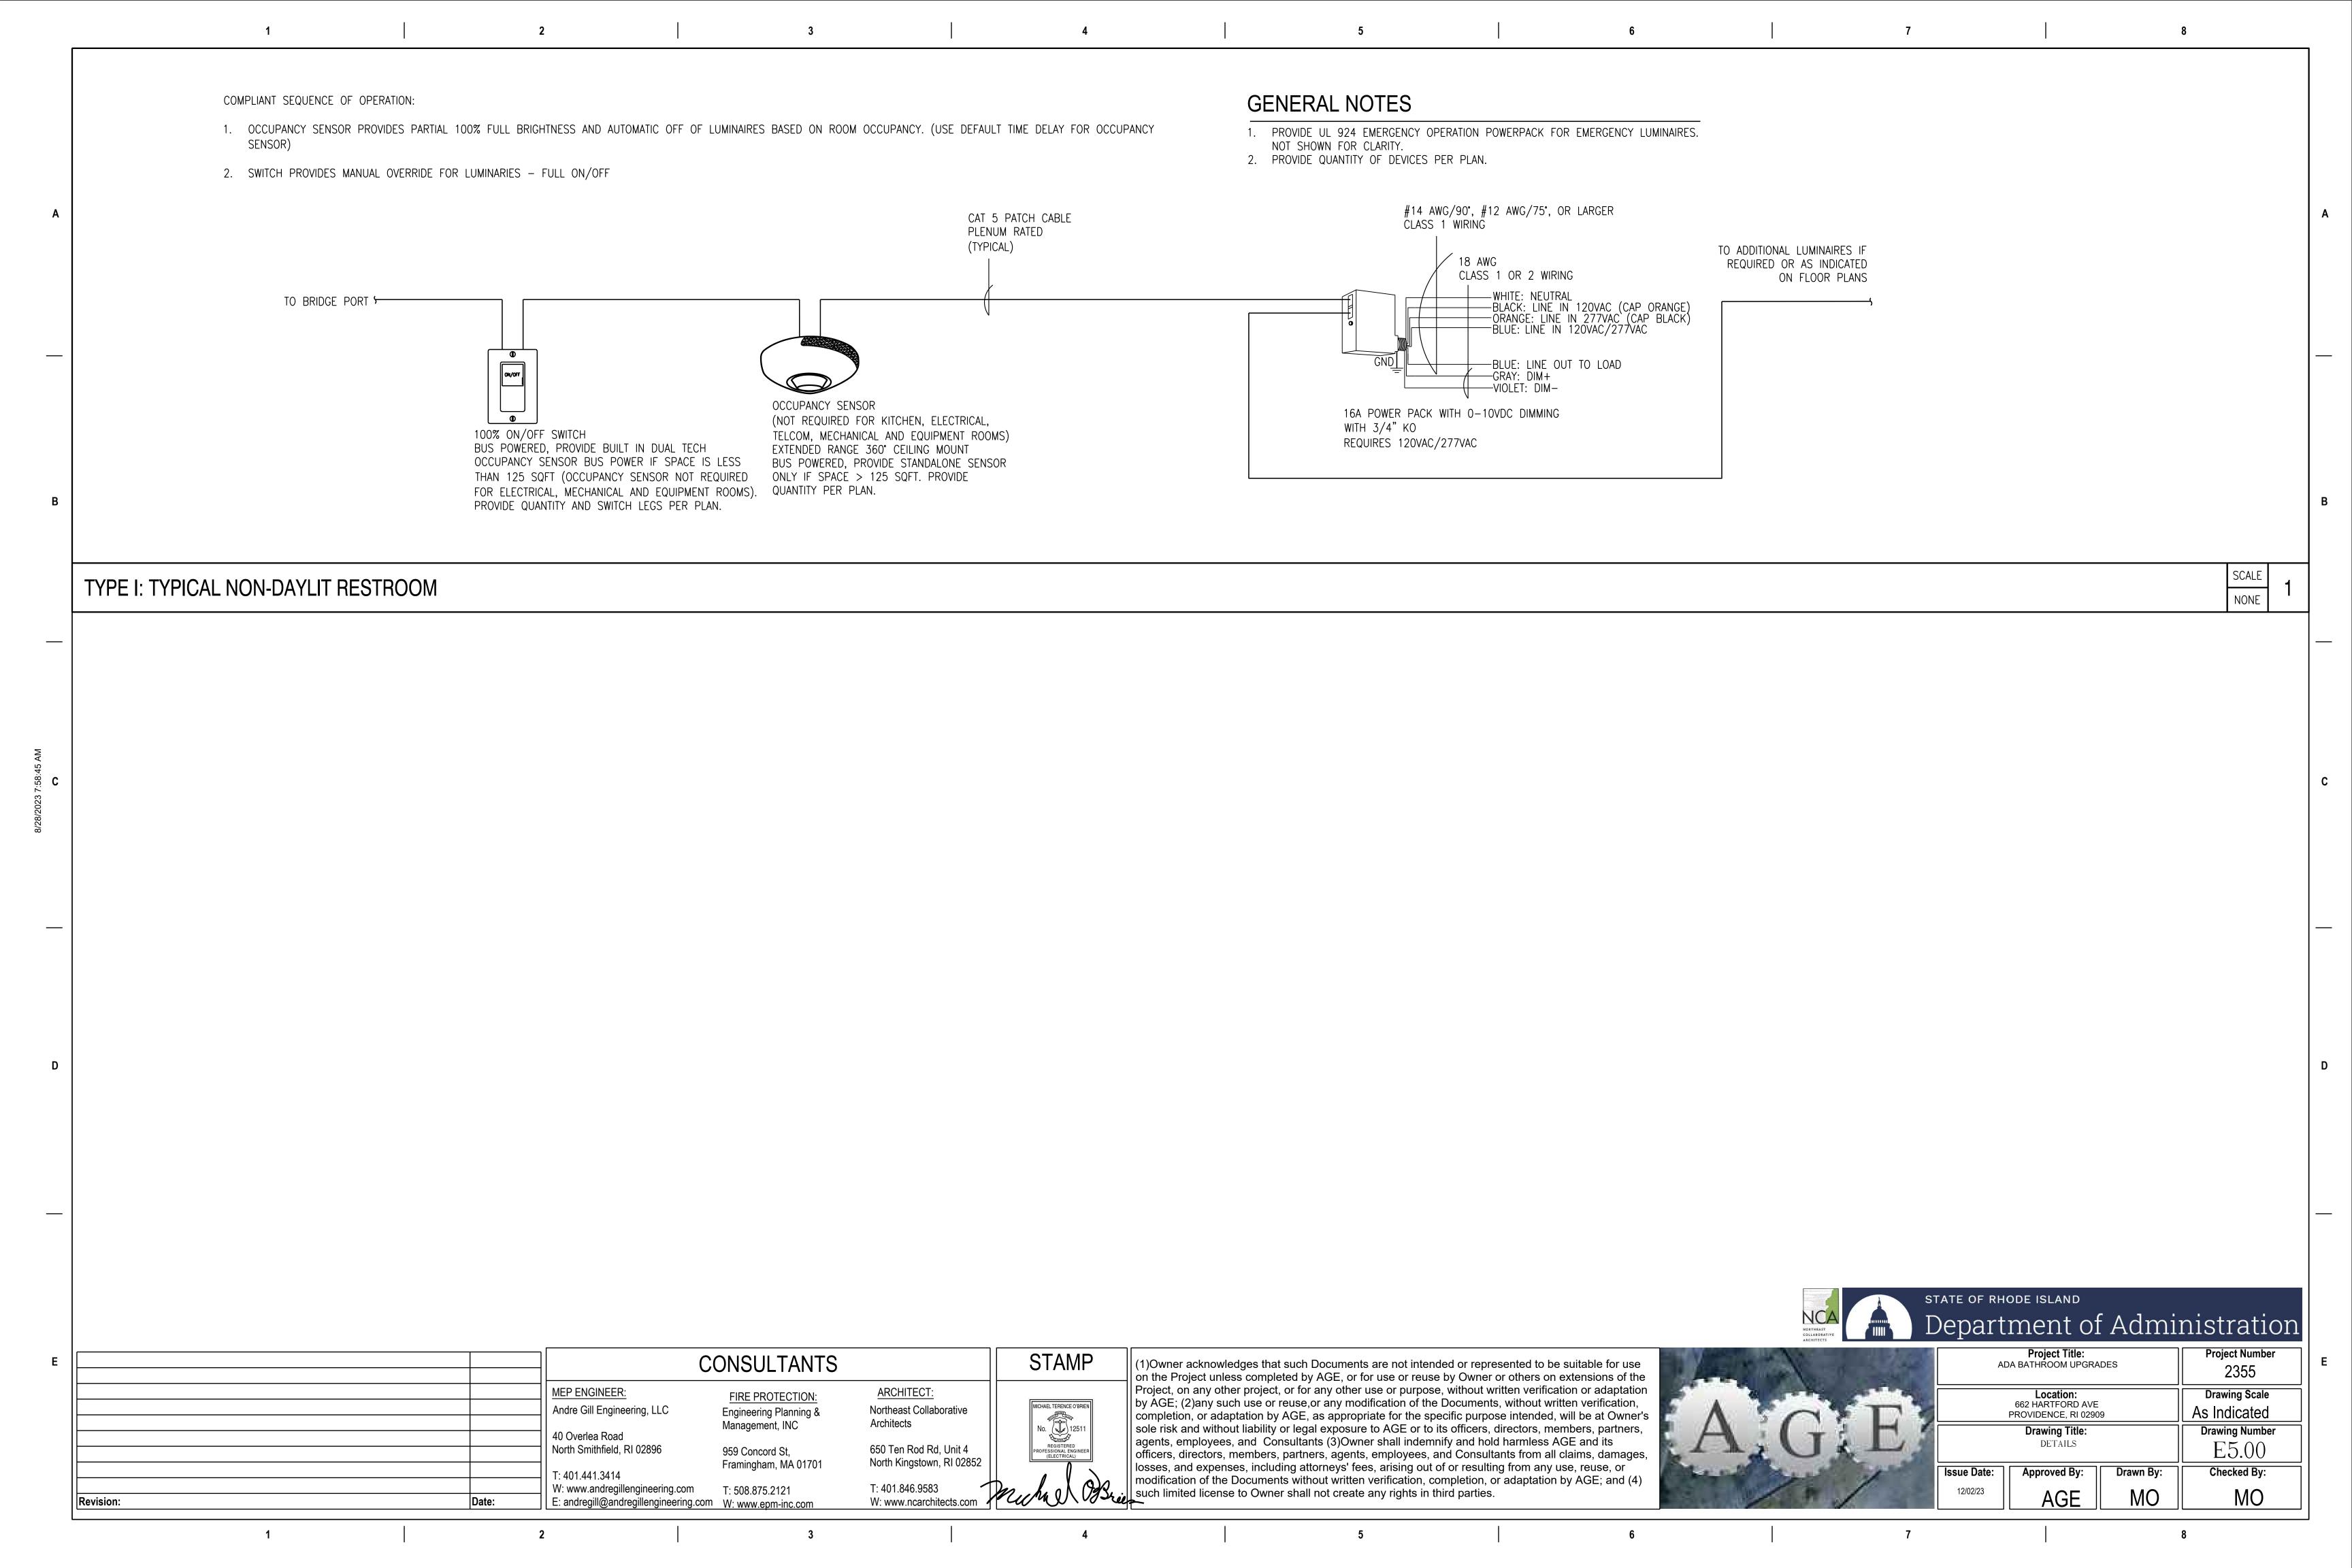
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d. PROVIDE MARK-UP OF SCOPE OF DUCTWORK BEING INCLUDED FOR CLEANING. ALL CONTRACTORS SHALL FOLLOW THE CURRENT ENFORCED RHODE ISLAND

STATE BUILDING CODES AS A MINIMUM, HOWEVER SECTIONS OF THESE DOCUMENTS REFLECT CURRENT VERSION OF ICC INTERNATIONAL CODES WHERE THEY SUPERSEDE RISBC. ALL CONTRACTORS SHALL FOLLOW ALL LOCAL REQUIREMENTS BY AUTHORITIES HAVING JURISDICTION.

CONTRACTOR SHALL OBTAIN AND PAY FOR PERMITS, INSPECTIONS AND TESTS REQUIRED BY GOVERNING AUTHORITIES HAVING JURISDICTION

MAINTAIN COMPLIANCE WITH OSHA THROUGHOUT THE CONSTRUCTION PHASE AND WITH COMPLETED WORK

E. THE FOLLOWING ARE THE GENERAL CLASSIFICATIONS OF WORK INCLUDED IN, BUT NOT LIMITED TO THIS SECTION

DEMOLITION AND MAKE SAFE EXISTING PIPING, DUCTWORK AND ASSOCIATED HANGERS AS INDICATED ON DRAWINGS

DEMOLITION AND MAKE SAFE EXISTING ELECTRICAL AND CONDUIT AS REQUIRED

CUTTING AND PATCHING FOR ALL MECHANICAL WORK. COORDINATION AND COOPERATION WITH CONTRACTORS AND SUPPLIERS FOR OTHER SECTIONS AND WITH THE OWNER.

AS- BUILT DRAWINGS.

ISSUE FOR PERMIT

DEMO NOTES

- PRIOR TO SUBMITTING BID. THE CONTRACTOR SHALL VISIT THE PROJECT SITE TO BECOME FAMILIAR WITH ALL EXISTING CONDITIONS AND TO DETERMINE THE EXTENT OF WORK TO REMOVE THE EXISTING PLUMBING SYSTEM INDICATED TO BE REMOVED. REQUEST FOR COMPENSATION FOR EXTRA WORK, WHICH WOULD HAVE BEEN EVIDENT BY COMPLIANCE WITH THE PREVIOUS STATEMENT, WILL NOT BE CONSIDERED.
- EXISTING CONDITIONS INFORMATION SHOWN AND/OR INDICATED ON THE DRAWINGS WERE OBTAINED FROM LIMITED EXISTING DRAWINGS PREPARED BY OTHERS: NON-DESTRUCTIVE FIELD INVESTIGATION REVIEW; FIELD MEASUREMENT; OTHER AVAILABLE DOCUMENTATION. NOT ALL EXISTING CONDITIONS &/or ACTUAL CONSTRUCTION MAY BE INDICATED AND/OR KNOWN.

CONTRACTOR SHALL FIELD VERIFY ALL EXISTING, CONDITIONS, CONNECTIONS, LOCATIONS, SIZES, ETC. IN THE FIELD AND NOTIFY THE ENGINEER OF RECORD OF ANY DISCREPANCIES BEFORE STARTING

- CONTRACTOR SHALL COORDINATE EXTENTS OF ALL DEMOLITION WORK WITH ALL NEW WORK AND NOTIFY THE ARCHITECT AND ENGINEER OF RECORD OF ANY DISCREPANCIES BEFORE STARTING DEMOLITION
- CONTRACTOR SHALL MAKE SAFE AND PROPERLY DE-ENERGIZE, SHUT OFF & CAP ALL UTILITIES (ELECTRICAL, GAS, WATER, SEWER, TELEPHONE, ETC.)
- VERIFY PIPING SERVES ONLY PLUMBING FIXTURES INDICATED FOR DEMOLITION BEFORE SHUT-DOWN FOR DISCONNECTION. IDENTIFY EXISTING PIPING WHICH SERVES FIXTURES TO REMAIN. NOTIFY ARCHITECT OF ACTIVE PIPING TO BE MAINTAINED WHEN LOCATED IN PARTITION TO BE DEMOLISHED.
- COORDINATE ALL SHUT-DOWNS, TIE-INS, ETC., WITH THE G.C. ELECTRICAL MAKE-SAFE OF PLUMBING EQUIPMENT REQUIRING DEMOLITION SHALL BE COMPLETED BY THE ELECTRICAL SUBCONTRACTOR. FULL EXTENT OF MEP MATERIALS ARE UNKNOWN. EXISTING BUILDING CONSTRUCTION MAY CONTAIN MATERIALS THAT REQUIRE ABATEMENT. IF POTENTIAL MATERIALS ARE DISCOVERED, CONTRACTOR SHALL
- NOTIFY OWNER & ARCHITECT BEFORE PROCEEDING WITH WORK. CONTRACTOR SHALL PROTECT ALL EXISTING WORK TO REMAIN DURING DEMOLITION. CONTRACTOR TO FURNISH AND INSTALL ALL SHORING AND/OR BRACING TO SUPPORT ALL EXISTING WALLS, FLOORS/ROOFS, ETC. PRIOR TO REMOVALS OF EXISTING CONSTRUCTION. DEMOLITION SUBCONTRACTOR MUST PROTECT EXISTING SLAB, WALL, FENCING AND BUILDING STRUCTURE DURING DEMOLITION PHASE. DAMAGE TO EXISTING STRUCTURE SHALL BE REPAIRED AT DEMOLITION
- THE APPLICABLE NATIONAL, STATE, AND LOCAL CODES, LAWS AND ORDINANCES. EXISTING DEFICIENCIES NOT INDICATED ON THE DRAWINGS, BUT UNCOVERED AND/OR DISCOVERED BY CONTRACTOR'S CONSTRUCTION ACTIVITIES SHALL BE REPORTED TO THE ENGINEER OF RECORD FOR REVIEW PRIOR TO INSTALLATION OF NEW WORK. ADDITIONAL DETAILS WILL BE FURNISHED AS NECESSARY.

SUBCONTRACTORS EXPENSE. ALL DEMOLITION WORK PERFORMED SHALL BE DONE IN ACCORDANCE WITH

GENERAL NOTES

- A. THERE SHALL BE NO SERVICE INTERRUPTION PRIOR TO COMMENCING WORK CONTRACTOR SHALL VERIFY EXACT LOCATION OF DOMESTIC WATER, VENT
- AND DEPTH OF EXISTING SEWER LINES IN THE FIELD. ALL PIPING SHALL BE IDENTIFIED ON REDLINE DRAWINGS TO BE PROVIDED BY CONTRACTOR TO ENGINEER, OWNER AND ARCHITECT. INCLUDING SIZE, INVERT ELEVATIONS, DIRECTION OF FLOW PROVIDE ALL MATERIALS AND EQUIPMENT AND PERFORM ALL LABOR REQUIRED TO INSTALL COMPLETE AND OPERABLE MECHANICAL SYSTEMS AS INDICATED ON THE DRAWINGS, AS SPECIFIED AND AS REQUIRED BY
- CONTRACT DOCUMENT DRAWINGS FOR MECHANICAL WORK (HVAC. PLUMBING. AND FIRE PROTECTION) ARE

DIAGRAMMATIC AND ARE INTENDED TO CONVEY SCOPE AND GENERAL ARRANGEMENT ONLY. INSTALL ALL MECHANICAL EQUIPMENT AND APPURTENANCES IN ACCORDANCE WITH MANUFACTURERS '

RECOMMENDATIONS, CONTRACT DOCUMENTS, AND APPLICABLE CODES AND REGULATIONS. ALL PIPING ON THIS PLAN SHALL BE CONCEALED UNLESS OTHERWISE NOTED.

REPAIR PAVING/FLOOR AFTER INSTALLATION AND INSPECTION OF UTILITIES INSTALLED. PAINT FLOOR TO MATCH PREVIOUS OR MATCH AND COMPLY WITH ARCHITECTURAL DRAWINGS. CONTRACTOR TO RECONNECT EXISTING ELECTRICAL GROUNDING/BONDING TO COLD WATER PIPING SYSTEM.

PROVIDE VIBRATION ISOLATION FOR ALL MECHANICAL EQUIPMENT TO PREVENT TRANSMISSION OF VIBRATION TO BUILDING STRUCTURE PROVIDE VIBRATION ISOLATORS FOR ALL PIPING SUPPORTS CONNECTED TO AND WITHIN 50 FEET OF ISOLATED EQUIPMENT (EXCEPT AT BASE ELBOW SUPPORTS AND ANCHOR POINTS) THROUGHOUT

OR PRESSURE REDUCING VALVES. PROVIDE VIBRATION ISOLATORS FOR ALL PIPING SUPPORTS OF STEAM MAINS WITHIN 50 FEET OF BOILERS

MECHANICAL EQUIPMENT ROOMS. DO THE SAME FOR SUPPORTS OF STEAM MAINS WITHIN 50 FEET OF BOILER

AND PRESSURE REDUCING VALVES. THE LOCATION OF EXISTING UNDERGROUND/UNDERSLAB UTILITIES IS SHOWN IN AN APPROXIMATE WAY ONLY. THE CONTRACTOR SHALL DETERMINE THE EXACT LOCATION OF ALL EXISTING UTILITIES BEFORE COMMENCING WORK. THE CONTRACTOR SHALL PAY FOR AND REPAIR ALL DAMAGES CAUSED BY FAILURE TO EXACTLY LOCATE AND PRESERVE ANY AND ALL UNDERGROUND UTILITIES UNLESS OTHERWISE INDICATED. COORDINATE CONSTRUCTION OF ALL MECHANICAL WORK WITH ARCHITECTURAL, STRUCTURAL, CIVIL,

ELECTRICAL WORK, ETC., SHOWN ON OTHER CONTRACT DOCUMENT DRAWINGS. MAINTAIN A MINIMUM OF 6'-8" CLEARANCE TO UNDERSIDE OF PIPES, DUCTS, CONDUITS, SUSPENDED

EQUIPMENT, ETC., THROUGHOUT ACCESS ROUTES IN MECHANICAL ROOMS. ALL TESTS SHALL BE COMPLETED BEFORE ANY MECHANICAL EQUIPMENT OR PIPING INSULATION IS APPLIED. LOCATE ALL TEMPERATURE, PRESSURE, AND FLOW MEASURING DEVICES IN ACCESSIBLE LOCATIONS WITH STRAIGHT SECTION OF PIPE OR DUCT UP- AND DOWNSTREAM AS RECOMMENDED BY THE MANUFACTURER

FOR GOOD ACCURACY. PROVIDE ACCESS PANELS WHERE REQUIRED. TESTING, ADJUSTING, AND BALANCING AGENCY SHALL BE A MEMBER OF THE ASSOCIATED AIR BALANCE COUNCIL (AABC) OR THE NATIONAL ENVIRONMENTAL BALANCING BUREAU (NEBB). TESTING, ADJUSTING, AND

BALANCING SHALL BE PERFORMED IN ACCORDANCE WITH THE AABC STANDARDS. WHERE TWO OR MORE ITEMS OF THE SAME TYPE OF EQUIPMENT ARE REQUIRED, THE PRODUCT OF ONE

REINFORCEMENT, DETAILING, AND PLACEMENT OF CONCRETE SHALL CONFORM TO ASTM 315 AND ACI 318. CONCRETE SHALL CONFORM TO ASTM C94. CONCRETE WORK SHALL CONFORM TO ACI 318, PART ENTITLED "CONSTRUCTION REQUIREMENTS." COMPRESSIVE STRENGTH IN 28 DAYS SHALL BE 3,000 PSI. TOTAL AIR CONTENT OF EXTERIOR CONCRETE SHALL BE BETWEEN 5 AND 7 PERCENT BY VOLUME. SLUMP SHALL BE

BETWEEN 3 AND 4 INCHES. CONCRETE SHALL BE CURED FOR 7 DAYS AFTER PLACEMENT. COORDINATE ALL EQUIPMENT CONNECTIONS WITH MANUFACTURERS 'CERTIFIED DRAWINGS. COORDINATE AND PROVIDE ALL DUCT AND PIPING TRANSITIONS REQUIRED FOR FINAL EQUIPMENT CONNECTIONS TO FURNISHED EQUIPMENT. FIELD VERIFY AND COORDINATE ALL DUCT AND PIPING DIMENSIONS BEFORE FABRICATION.

ALL CONTROL WIRE AND CONDUIT SHALL COMPLY WITH THE NATIONAL ELECTRIC CODE AND DIVISION 16 OF THE SPECIFICATION.

Q. CONCRETE HOUSEKEEPING PADS TO SUIT MECHANICAL EQUIPMENT SHALL BE SIZED AND LOCATED BY THE MECHANICAL CONTRACTOR. MINIMUM CONCRETE PAD THICKNESS SHALL BE 6 INCHES. PAD SHALL EXTEND BEYOND THE EQUIPMENT A MINIMUM OF 6 INCHES ON EACH SIDE. CONCRETE HOUSEKEEPING PADS SHALL BE PROVIDED BY THE GENERAL CONTRACTOR. IT SHALL BE THE RESPONSIBILITY OF THE MECHANICAL CONTRACTOR TO COORDINATE SIZE AND LOCATION OF CONCRETE HOUSEKEEPING PADS WITH GENERAL CONTRACTOR.

W. ALL MECHANICAL ROOM DOORS SHALL BE A MINIMUM OF 4 '-0" WIDE. WHERE BEAMS ARE INDICATED TO BE PENETRATED WITH DUCTWORK OR PIPING. COORDINATE DUCTWORK

AND PIPING LAYOUT WITH BEAM OPENING SIZE AND OPENING LOCATIONS. COORDINATION SHALL BE DONE PRIOR TO FABRICATION OF DUCTWORK, CUTTING OF PIPING, OR FABRICATION OF BEAMS. WHEN MECHANICAL WORK (HVAC, PLUMBING, SHEET METAL, FIRE PROTECTION, ETC.) IS SUBCONTRACTED. IT SHALL BE THE MECHANICAL CONTRACTOR'S RESPONSIBILITY TO COORDINATE SUBCONTRACTORS AND THE ASSOCIATED CONTRACTS. WHEN DISCREPANCIES ARISE PERTAINING TO WHICH CONTRACTOR PROVIDES A PARTICULAR ITEM OF THE MECHANICAL CONTRACT OR WHICH CONTRACTOR PROVIDES FINAL CONNECTIONS FOR A PARTICULAR ITEM OF THE MECHANICAL CONTRACT, IT SHALL BE BROUGHT TO THE ATTENTION OF THE

MECHANICAL CONTRACTOR, WHOSE DECISION SHALL BE FINAL. THE LOCATIONS OF ALL ITEMS SHOWN ON THE DRAWINGS OR CALLED FOR IN THE SPECIFICATIONS THAT ARE NOT DEFINITELY FIXED BY DIMENSIONS ARE APPROXIMATE ONLY. THE EXACT LOCATIONS NECESSARY TO SECURE THE BEST CONDITIONS AND RESULTS MUST BE DETERMINED BY THE PROJECT SITE CONDITIONS AND

SHALL HAVE THE APPROVAL OF THE ENGINEER BEFORE BEING INSTALLED. DO NOT SCALE DRAWINGS. AA. ALL MISCELLANEOUS STEEL REQUIRED TO ENSURE PROPER INSTALLATION AND AS SHOWN IN DETAILS FOR PIPING, DUCTWORK, AND EQUIPMENT (UNLESS OTHERWISE NOTED) SHALL BE FURNISHED AND INSTALLED BY THE MECHANICAL CONTRACTOR.

AB. PROVIDE ACCESS PANELS FOR INSTALLATION IN WALLS AND CEILINGS. WHERE REQUIRED. TO SERVICE DAMPERS, VALVES, SMOKE DETECTORS, AND OTHER CONCEALED MECHANICAL EQUIPMENT. ACCESS PANELS

SHALL BE TURNED OVER TO GENERAL CONTRACTOR FOR INSTALLATION. AC. ALL EQUIPMENT, PIPING, DUCTWORK, ETC., SHALL BE SUPPORTED AS DETAILED, SPECIFIED, AND REQUIRED

TO PROVIDE A VIBRATION FREE INSTALLATION. AD. ALL DUCTWORK, PIPING AND EQUIPMENT SUPPORTED FROM STRUCTURAL STEEL SHALL BE COORDINATED WITH GENERAL CONTRACTOR. ALL ATTACHMENTS TO STEEL BAR JOISTS, TRUSSES, OR JOIST GIRDERS SHALL

BE AT PANEL POINTS. PROVIDE BEAM CLAMPS MEETING MSS STANDARDS. AE. WELDING TO STRUCTURAL MEMBERS SHALL NOT BE PERMITTED. THE USE OF C-CLAMPS SHALL NOT BE

AF. MECHANICAL EQUIPMENT, DUCTWORK, AND PIPING SHALL NOT BE SUPPORTED FROM METAL DECK. AG. ALL ROOF MOUNTED EQUIPMENT CURBS FOR EQUIPMENT PROVIDED BY THE MECHANICAL CONTRACTOR

AH. LOCATIONS AND SIZES OF ALL FLOOR, WALL, AND ROOF OPENINGS SHALL BE COORDINATED WITH ALL OTHER AI. ALL OPENINGS IN FIRE WALLS DUE TO DUCTWORK, PIPING, CONDUIT, ETC., SHALL BE FIRE STOPPED WITH A

SHALL BE FURNISHED BY THE MECHANICAL CONTRACTOR AND INSTALLED BY THE GENERAL CONTRACTOR.

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PRODUCT SIMILAR TO 3M OR APPROVED EQUAL. AJ. ALL AIR CONDITIONING CONDENSATE DRAIN LINES FROM EACH AIR HANDLING UNIT AND ROOFTOP UNIT SHALL BE PIPED FULL SIZE OF THE UNIT DRAIN OUTLET, WITH "P" TRAP, AND PIPED TO NEAREST DRAIN. SEE DETAILS SHOWN ON THE DRAWINGS OR THE CONTRACT SPECIFICATIONS FOR DEPTH OF AIR CONDITIONING

AK. REFER TO TYPICAL DETAILS FOR DUCTWORK, PIPING, AND EQUIPMENT INSTALLATION.

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HVAC/ SHEETMETAL NOTES

- PROVIDE ALL MATERIALS AND EQUIPMENT AND PERFORM ALL LABOR REQUIRED TO INSTALL COMPLETE AND OPERABLE HVAC SYSTEMS AS INDICATED ON THE DRAWINGS. AS SPECIFIED AND AS REQUIRED BY CODE.
- CERTAIN ITEMS SUCH AS RISES AND DROPS IN DUCTWORK, ACCESS DOORS, VOLUME DAMPERS, ETC., ARE INDICATED ON THE CONTRACT DOCUMENT DRAWINGS FOR CLARITY FOR A SPECIFIC LOCATION REQUIREMENT AND SHALL NOT BE INTERPRETED AS THE EXTENT OF THE REQUIREMENTS FOR THESE ITEMS. CONTRACTOR IS REQUIRED TO INSTALL ACCESSORIES INCLUDED BUT NOT LIMITED TO ACCESS PANELS, DAMPERS (INCLUDING FIRE, SMOKE AND COMBO), TEST PORTS AS REQUIRED BY CODE. FIRE AND SMOKE DAMPERS SHALL BE INSTALLED AT A MINIMUM OF ALL FIRE WALL PENETRATIONS UNLESS EXEMPT BY CODE. FIRE AN DUCT SMOKES SHALLED BE INSTALLED WITH IN 5' OF THE DAMPER WHEN REQUIRED, UNLESS OTHERWISE

INSULATE THE FOLLOWING:

- a. ALL SUPPLY AIR, OUTDOOR AIR,
- EXAUST AND RELIEF AIR BETWEEN THE MOTOR-OPERATED DAMPER AND PENETRATION OF THE BUILIDING EXTERIOR.
- ALL DUCTWORK LOCATED IN UNCONDITIONED SPACES OR OUTSIDE BUIDLING
- ALL DUCTWORK LOCATED IN ATTICS, WHETER VENTILATED OR UNVENTILATED. ALL DUCTWORK BURIED EITHER OUTSIDE THE BUILDING OR BELOW FLOORS
- ALL SURFACES SHOULD BE RESISTANT TO MOLD GROWTH AND RESIST EROSION, ACCORDING TO THE REQUIREMENTS OF ASHRAE STANDARD 62.1. IN CORRIDORS WHERE CEILING SPEAKERS AND AIR DIFFUSERS ARE INDICATED
- BETWEEN THE SAME LIGHT FIXTURES, INSTALL BOTH DEVICES AT THE QUARTER POINTS BETWEEN THE SAME FIXTURE. UNLESS OTHERWISE SHOWN, LOCATE ALL ROOM THERMOSTATS AND HUMIDISTATS

4'-0" (CENTERLINE) ABOVE FINISHED FLOOR, NOTIFY THE ENGINEER OF ANY ROOMS WHERE THE ABOVE LOCATION CANNOT BE MAINTAINED OR WHERE THERE IS A QUESTION ON LOCATION.

ALL DUCTWORK SHALL CLEAR DOORS AND WINDOWS. ALL DUCTWORK DIMENSIONS, AS SHOWN ON THE DRAWINGS, ARE INTERNAL CLEAR DIMENSIONS AND DUCT SIZE SHALL BE INCREASED TO COMPENSATE FOR DUCT LINING

THICKNESS PROVIDE ALL 90 DEGREE SQUARE ELBOWS WITH DOUBLE RADIUS TURNING VANES UNLESS OTHERWISE INDICATED. ELBOWS IN DISHWASHER, KITCHEN, AND LAUNDRY EXHAUST SHALL BE UNVANED SMOOTH RADIUS CONSTRUCTION WITH A RADIUS EQUAL TO 11/2 TIMES THE WIDTH OF THE DUCT. PROVIDE ACCESS DOORS UPSTREAM OF ALL

ELBOWS WITH TURNING VANES. COORDINATE DIFFUSER, REGISTER, AND GRILLE LOCATIONS WITH ARCHITECTURAL REFLECTED CEILING PLANS, LIGHTING, AND OTHER CEILING ITEMS AND MAKE MINOR

FIELD ERECTED AND FACTORY ASSEMBLED AIR HANDLING UNIT COILS SHALL BE ARRANGED FOR REMOVAL FROM THE UPSTREAM SIDE WITHOUT DISMANTLING SUPPORTS. PROVIDE GALVANIZED STRUCTURAL STEEL SUPPORTS FOR ALL COILS (EXCEPT LOWEST COIL) IN BANKS OVER TWO COILS HIGH TO PERMIT INDEPENDENT

REMOVAL OF ANY COIL. ALL AIR HANDLING UNITS SHALL OPERATE WITHOUT MOISTURE CARRYOVER. LOCATE ALL MECHANICAL EQUIPMENT (SINGLE DUCT, DUAL DUCT, VARIABLE VOLUME CONSTANT VOLUME AND FAN POWERED BOXES, FAN COIL UNITS, CABINET HEATERS,

UNIT HEATERS, UNIT VENTILATORS, COILS, STEAM HUMIDIFIERS, ETC.) FOR UNOBSTRUCTED ACCESS TO UNIT ACCESS PANELS, CONTROLS AND VALVING. FINNED TUBE RADIATION ENCLOSURES SHALL BE WALL TO WALL UNLESS OTHERWISE

INDICATED. PROVIDE FLEXIBLE CONNECTIONS IN ALL DUCTWORK SYSTEMS (SUPPLY, RETURN, AND EXHAUST) CONNECTED TO AIR HANDLING UNITS, FANS, AND OTHER EQUIPMENT WHICH REQUIRE VIBRATION ISOLATION. FLEXIBLE CONNECTIONS SHALL BE PROVIDED AT THE POINT OF CONNECTION TO THE EQUIPMENT UNLESS OTHERWISE INDICATED.

UNLESS OTHERWISE NOTED, ALL DUCTWORK IS OVERHEAD, TIGHT TO THE UNDERSIDE OF THE STRUCTURE, WITH SPACE FOR INSULATION IF REQUIRED. RUNS OF FLEXIBLE DUCT SHALL NOT EXCEED 5 FEET (EDIT MAXIMUM LENGTH OF FLEXIBLE DUCT TO SUIT PROJECT; 5 FEET MAXIMUM RECOMMENDED LENGTH, 8 FEET

MAXIMUM LENGTH). ALL DUCTWORK SHALL BE COORDINATED WITH ALL TRADES INVOLVED. OFFSETS IN DUCTS. INCLUDING DIVIDED DUCTS AND TRANSITIONS AROUND OBSTRUCTIONS, SHALL BE PROVIDED AT NO ADDITIONAL COST TO THE OWNER.

PROVIDE ACCESS DOORS IN DUCTWORK TO PROVIDE ACCESS FOR ALL SMOKE DETECTORS, FIRE DAMPERS, SMOKE DAMPERS, VOLUME DAMPERS, HUMIDIFIER(COILS, AND OTHER ITEMS LOCATED IN THE DUCTWORK WHICH REQUIRE SERVICE AND/OR INSPECTION

PROVIDE ACCESS DOORS IN DUCTWORK FOR OPERATION, ADJUSTMENT, AND MAINTENANCE OF ALL FANS, VALVES, AND MECHANICAL EQUIPMENTS. ALL DUCTS SHALL BE GROUNDED ACROSS FLEXIBLE CONNECTIONS WITH FLEXIBLE COPPER GROUNDING STRAPS. GROUNDING STRAPS SHALL BE BOLTED OR SOLDERED TO BOTH THE EQUIPMENT AND THE DUCT.

SMOKE DETECTORS SHALL BE FURNISHED AND WIRED BY THE ELECTRICAL CONTRACTOR. THE MECHANICAL CONTRACTOR SHALL BE RESPONSIBLE FOR

MOUNTING THE SMOKE DETECTOR IN DUCTWORK AS SHOWN ON THE DRAWINGS AND IN ACCORDANCE WITH MANUFACTURER'S PRINTED INSTRUCTIONS. TERMINATE GAS VENTS FOR UNIT HEATERS, WATER HEATERS, HIGH PRESSURE PARTS WASHER, HIGH PRESSURE CLEANER, AND OTHER GAS APPLIANCES A MINIMUM OF 3 '0"

ABOVE ROOF WITH RAIN CAP (EDIT APPLIANCES AND HEIGHT ABOVE ROOF TO MEET CODE AND TO SUIT PROJECT REQUIREMENTS). SEE SPECIFICATIONS FOR DUCTWORK GAUGES, BRACING, HANGERS, AND OTHER

REQUIREMENTS

EXTERIOR LOUVERS ARE INDICATED FOR INFORMATION ONLY. DETAILED DESCRIPTIONS ARE PROVIDED IN THE ARCHITECTURAL SPECIFICATIONS.

INVOLVED.

EXTERIOR LOUVERS ARE INDICATED FOR INFORMATION ONLY. LOUVER SIZES,

LOCATIONS, AND DETAILS SHALL BE COORDINATED WITH GENERAL CONTRACTOR. EXTERIOR LOUVERS ARE INDICATED FOR INFORMATION ONLY, LOUVER SIZES. LOCATIONS, MOUNTING, AND DETAILS SHALL BE COORDINATED WITH OTHER TRADES

MECHANICAL - SHEET LIST										
DISCIPLINE	SHEET NUMBER	SHEET NAME	SHEET ISSUE DATE							
MECHANICAL	M0.01	MECHANICAL GENERAL	05DEC23							
MECHANICAL	M3.00	MAIN BATHROOMS	05DEC23							
MECHANICAL	M3.01	STAFF BATHROOMS	05DEC23							
MECHANICAL	M3.2	MECHANICAL ROOM	05DEC23							
MECHANICAL	M5.00	MECHANICAL SCHEDULE	05DEC23							

			NOA NORTHEAST COLLABORATIVE ARCHITECTS	Department of Adm	inistration
CONSULTANTS	STAMP	(1)Owner acknowledges that such Documents are not intended or represented to be suitable for use on the Project unless completed by AGE, or for use or reuse by Owner or others on extensions of the		Project Title: ADA BATHROOM UPGRADES	Project Number 2355
	1 1			<u> </u>	

Project, on any other project, or for any other use or purpose, without written verification or adaptation by AGE; (2)any such use or reuse,or any modification of the Documents, without written verification, completion, or adaptation by AGE, as appropriate for the specific purpose intended, will be at Owner's sole risk and without liability or legal exposure to AGE or to its officers, directors, members, partners, agents, employees, and Consultants (3)Owner shall indemnify and hold harmless AGE and its officers, directors, members, partners, agents, employees, and Consultants from all claims, damages, losses, and expenses, including attorneys' fees, arising out of or resulting from any use, reuse, or modification of the Documents without written verification, completion, or adaptation by AGE; and (4) PROFESSIONAL ENGINEER such limited license to Owner shall not create any rights in third parties.

	Project Title: ADA BATHROOM UPGF	RADES	Project Number 2355
	Location: 662 HARTFORD AV PROVIDENCE, RI 02	Drawing Scale 12" = 1'-0"	
A.G.E.	Drawing Title: MECHANICAL GENE	Drawing Number MO.01	
	Issue Date: Approved By:	Drawn By:	Checked By:
The state of the s	05DEC23 AG	AGE	AG

E: andregill@andregillengineering.com W: www.epm-inc.com

MEP ENGINEER:

40 Overlea Road

10JAN24

Andre Gill Engineering, LLC

North Smithfield, RI 02896

W: www.andregillengineering.com

ANDRE GILL

REGISTERED

(MECHANICAL)

JANITORS CLOSET 100 CFM 105 CFM **MENS RESTROOM WOMENS** 105 CFM RESTROOM 105 CFM **VESTIBULE** 100 CFM

MECHANICAL CALLOUT NOTES INSTALL INLINE EXHAUST FAN ABOVE CEILING. ROUTE TO EA TERMINALS AND EXHAUST DISCHARGE THROUGH ROOF. INSTALL WALL MOUNTED DEHUMIDISTAT INSTALL CEILING MOUNTED EF-4 AND ROUTE EXHUAST TO ROOF. INSTALL DIGITAL HUMIDITY SENSOR

GENERAL MECHANICAL SHEET NOTES

- A. REPLACE AND RELOCATE SUPPLY AIR TERMINALS.
- B. EXHAUST RATES SHALL BE FIFTY (50) CFM PER FIXTURE IN ALL RESTROOMS. A
- FIXTURE INCLUDES (WATER CLOSET, URINAL, SHOWER HEAD). PROVIDE REDLINE DRAWINGS TO ENGINEER OF RECORD SHOWIING
- INFORMATION ABOVE UPON COMPLETION OF PROJECT FOR RECORD SET. CLEAN DUCTWORK WITH-IN BATHROOMS, WITH-IN THE SCOPE OF THE PROJECT.
- DRAWINGS ARE DIAGRAMMATIC: DETERMINE LOCATIONS OF SYSTEMS AND COMPONENTS IN FIELD. DO NOT SCALE DRAWINGS.
- NEITHER ACCURACY NOR COMPLETION OF UTILITY LOCATIONS SHOWN ON DRAWINGS IS GUARANTEED. DETERMINE EXACT LOCATIONS OF EXISTING UTILITIES IN FIELD, WHETHER OR NOT SHOWN ON DRAWINGS. EXERCISE CAUTION AND IDENTIFY LOCATIONS OF UNMARKED UTILITY LINES AS
- NECESSARY TO PERFORM WORK OF THIS SECTION. G. MAINTAIN COMPLIANCE WITH OSHA THROUGHOUT THE CONSTRUCTION PHASE
- AND WITH COMPLETED WORK. H. THE FOLLOWING ARE THE GENERAL CLASSIFICATIONS OF WORK INCLUDED IN,
- BUT NOT LIMITED TO THIS SECTION. DEMOLITION AND MAKE SAFE EXISTING PIPING, DUCTWORK AND ASSOCIATED
- HANGERS AS INDICATED ON DRAWINGS. J. DEMOLITION AND MAKE SAFE EXISTING ELECTRICAL AND CONDUIT AS
- REQUIRED
- CUTTING AND PATCHING FOR ALL MECHANICAL WORK.
- PROVIDE ACCESS PANELS IN NON-ACCESSIBLE AREAS (RATED OR NON RATED) MINIMUM 12"X12" SIZE. INSTALL LARGER ACCESS PANELS FOR LARGER EQUIPMENT AS REQUIRED BY CODE. COORDINATE WITH ARCHITECT FOR APPROVAL OF FINAL LOCATIONS PRIOR TO INSTALLATION.
- M. PROVIDE FIRESTOPPING AT PASS THROUGH PIPE PENETRATIONS THROUGH

STATE OF RHODE ISLAND Department of Administration

Project Title: ADA BATHROOM UPGRADES Project Number 2355 Location: 662 HARTFORD AVE Drawing Scale As indicated PROVIDENCE, RI 02909 Drawing Title: MAIN BATHROOMS Drawing Number M3.00Approved By: Checked By: Drawn By: Issue Date: AGE AG

CONSULTANTS ARCHITECT: FIRE PROTECTION: Northeast Collaborative Engineering Planning &

VESTIBULE

ANDRE GILL Architects 650 Ten Rod Rd, Unit 4 North Kingstown, RI 02852 REGISTERED PROFESSIONAL ENGINEER (MECHANICAL)

(N) BATHROOMS MECHANICAL 1/2" = 1'-0"

STAMP

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Management, INC 40 Overlea Road North Smithfield, RI 02896 959 Concord St, Framingham, MA 01701 T: 401.441.3414 **ISSUE FOR PERMIT** 10JAN24 T: 401.846.9583 T: 508.875.2121 W: www.andregillengineering.com E: andregill@andregillengineering.com W: www.epm-inc.com W: www.ncarchitects.com

MEP ENGINEER:

Andre Gill Engineering, LLC


MENS RESTROOM—

WOMENS

RESTROOM

Room

(D) BATHROOMS MECHANICAL 1/2" = 1'-0"

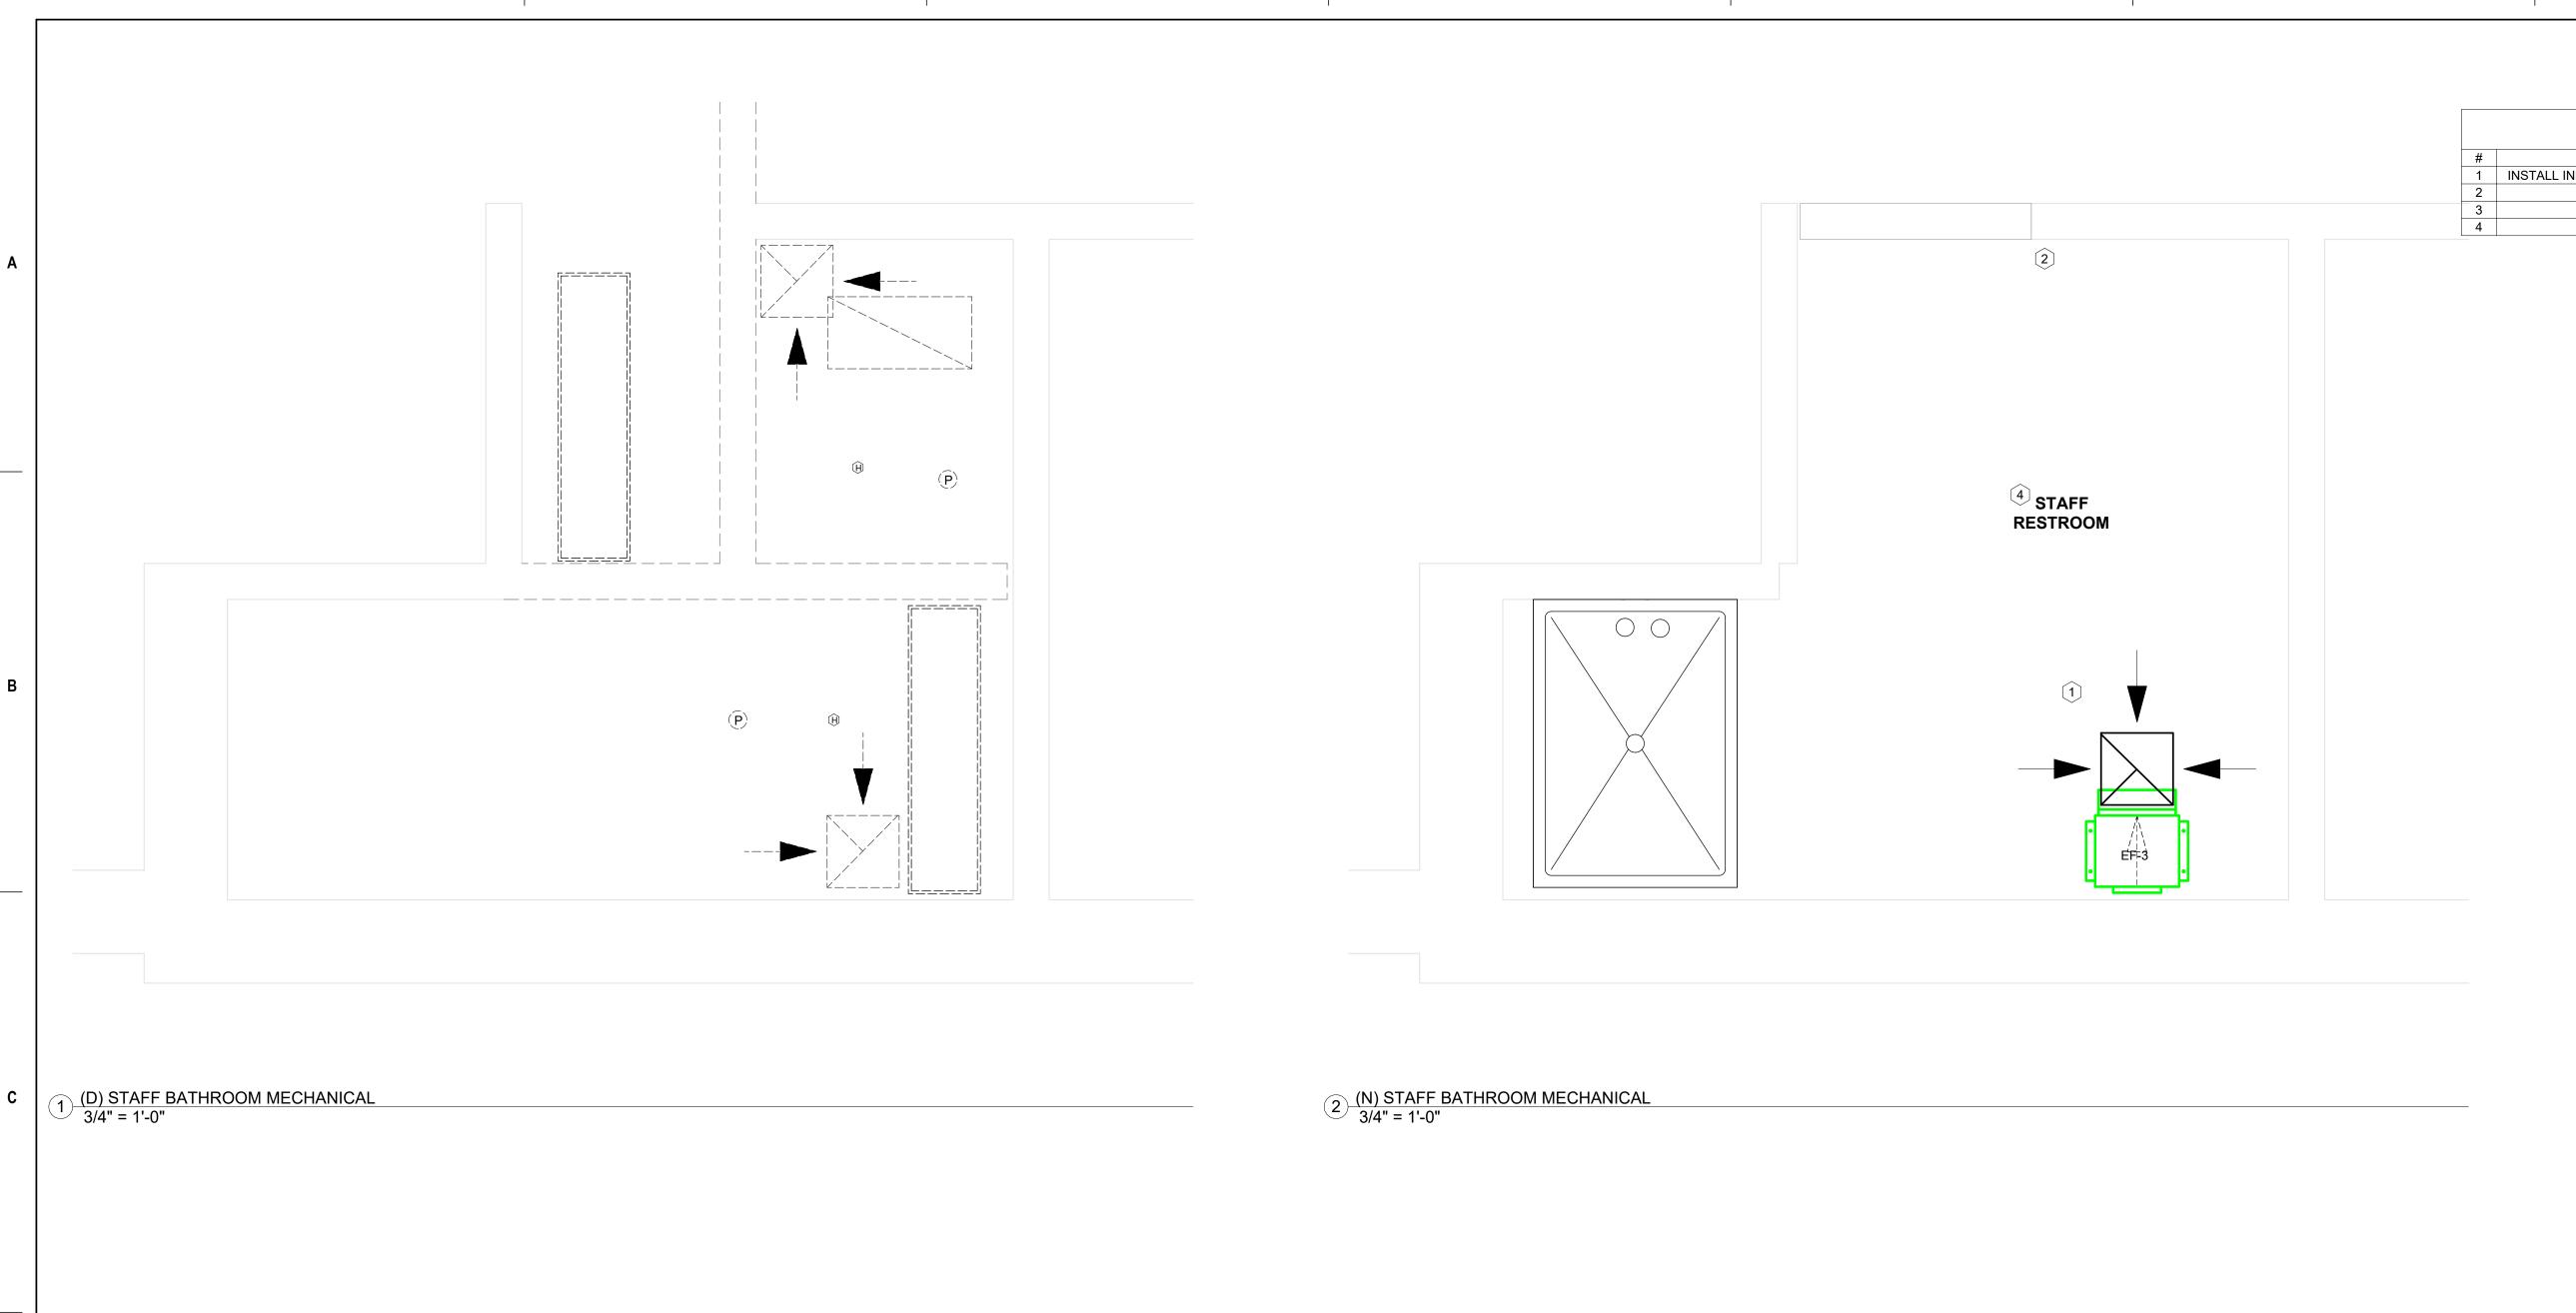

MECHANICAL CALLOUT NOTES INSTALL INLINE EXHAUST FAN ABOVE CEILING. ROUTE TO EA TERMINALS AND EXHAUST DISCHARGE THROUGH ROOF. INSTALL WALL MOUNTED DEHUMIDISTAT INSTALL CEILING MOUNTED EF-4 AND ROUTE EXHUAST TO ROOF. INSTALL DIGITAL HUMIDITY SENSOR

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- J. DEMOLITION AND MAKE SAFE EXISTING ELECTRICAL AND CONDUIT AS REQUIRED
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- M. PROVIDE FIRESTOPPING AT PASS THROUGH PIPE PENETRATIONS THROUGH



	AE	Project Title: DA BATHROOM UPGRA	Project Number 2355	
		Location: 662 HARTFORD AVE PROVIDENCE, RI 0290	Drawing Scale As indicated	
AUL		Drawing Title: STAFF BATHROOMS	Drawing Number M3.01	
	Issue Date:	Approved By:	Drawn By:	Checked By:
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		C	ONSULTANT
		MEP ENGINEER:	FIRE PROTECTION:
		Andre Gill Engineering, LLC	Engineering Planning & Management, INC
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Revision:	Date:	E: andregill@andregillengineering.com	W: www.epm-inc.com

CONSULTANTS

ARCHITECT: FIRE PROTECTION: Northeast Collaborative ndre Gill Engineering, LLC Engineering Planning & Architects Management, INC

> 650 Ten Rod Rd, Unit 4 959 Concord St, North Kingstown, RI 02852 Framingham, MA 01701


> > T: 401.846.9583

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ANDRE GILL REGISTERED PROFESSIONAL ENGINEER (MECHANICAL)

STAMP

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	EXHAUST FAN (EF-#)													
TYPE MARK	MARK	MANUFACTURER	AGE MODEL	CFM RANGE	AGE FREQUEN CY (HZ)	AGE PHASE	AGE VOLTAGE	EXTERNAL STATIC	RPM	HP	WATTS	NOTES		
	EF-1	Greenheck	CSP A390 QD	150-250	60	1	115	0.8	1,300		57.2			
	EF-2	Greenheck	CSP A390 QD	150-250	60	1	115	0.8	1,300		57.2			
	EF-3	Greenheck	CSP A390 QD	150-250	60	1	115	0.2	1,300		57.2			
	EF-4	Greenheck	SP A110 QD	98-130	60	1	115	0.15	950		18.5			

DIGITAL HUMIDITY SENSOR PN 386429

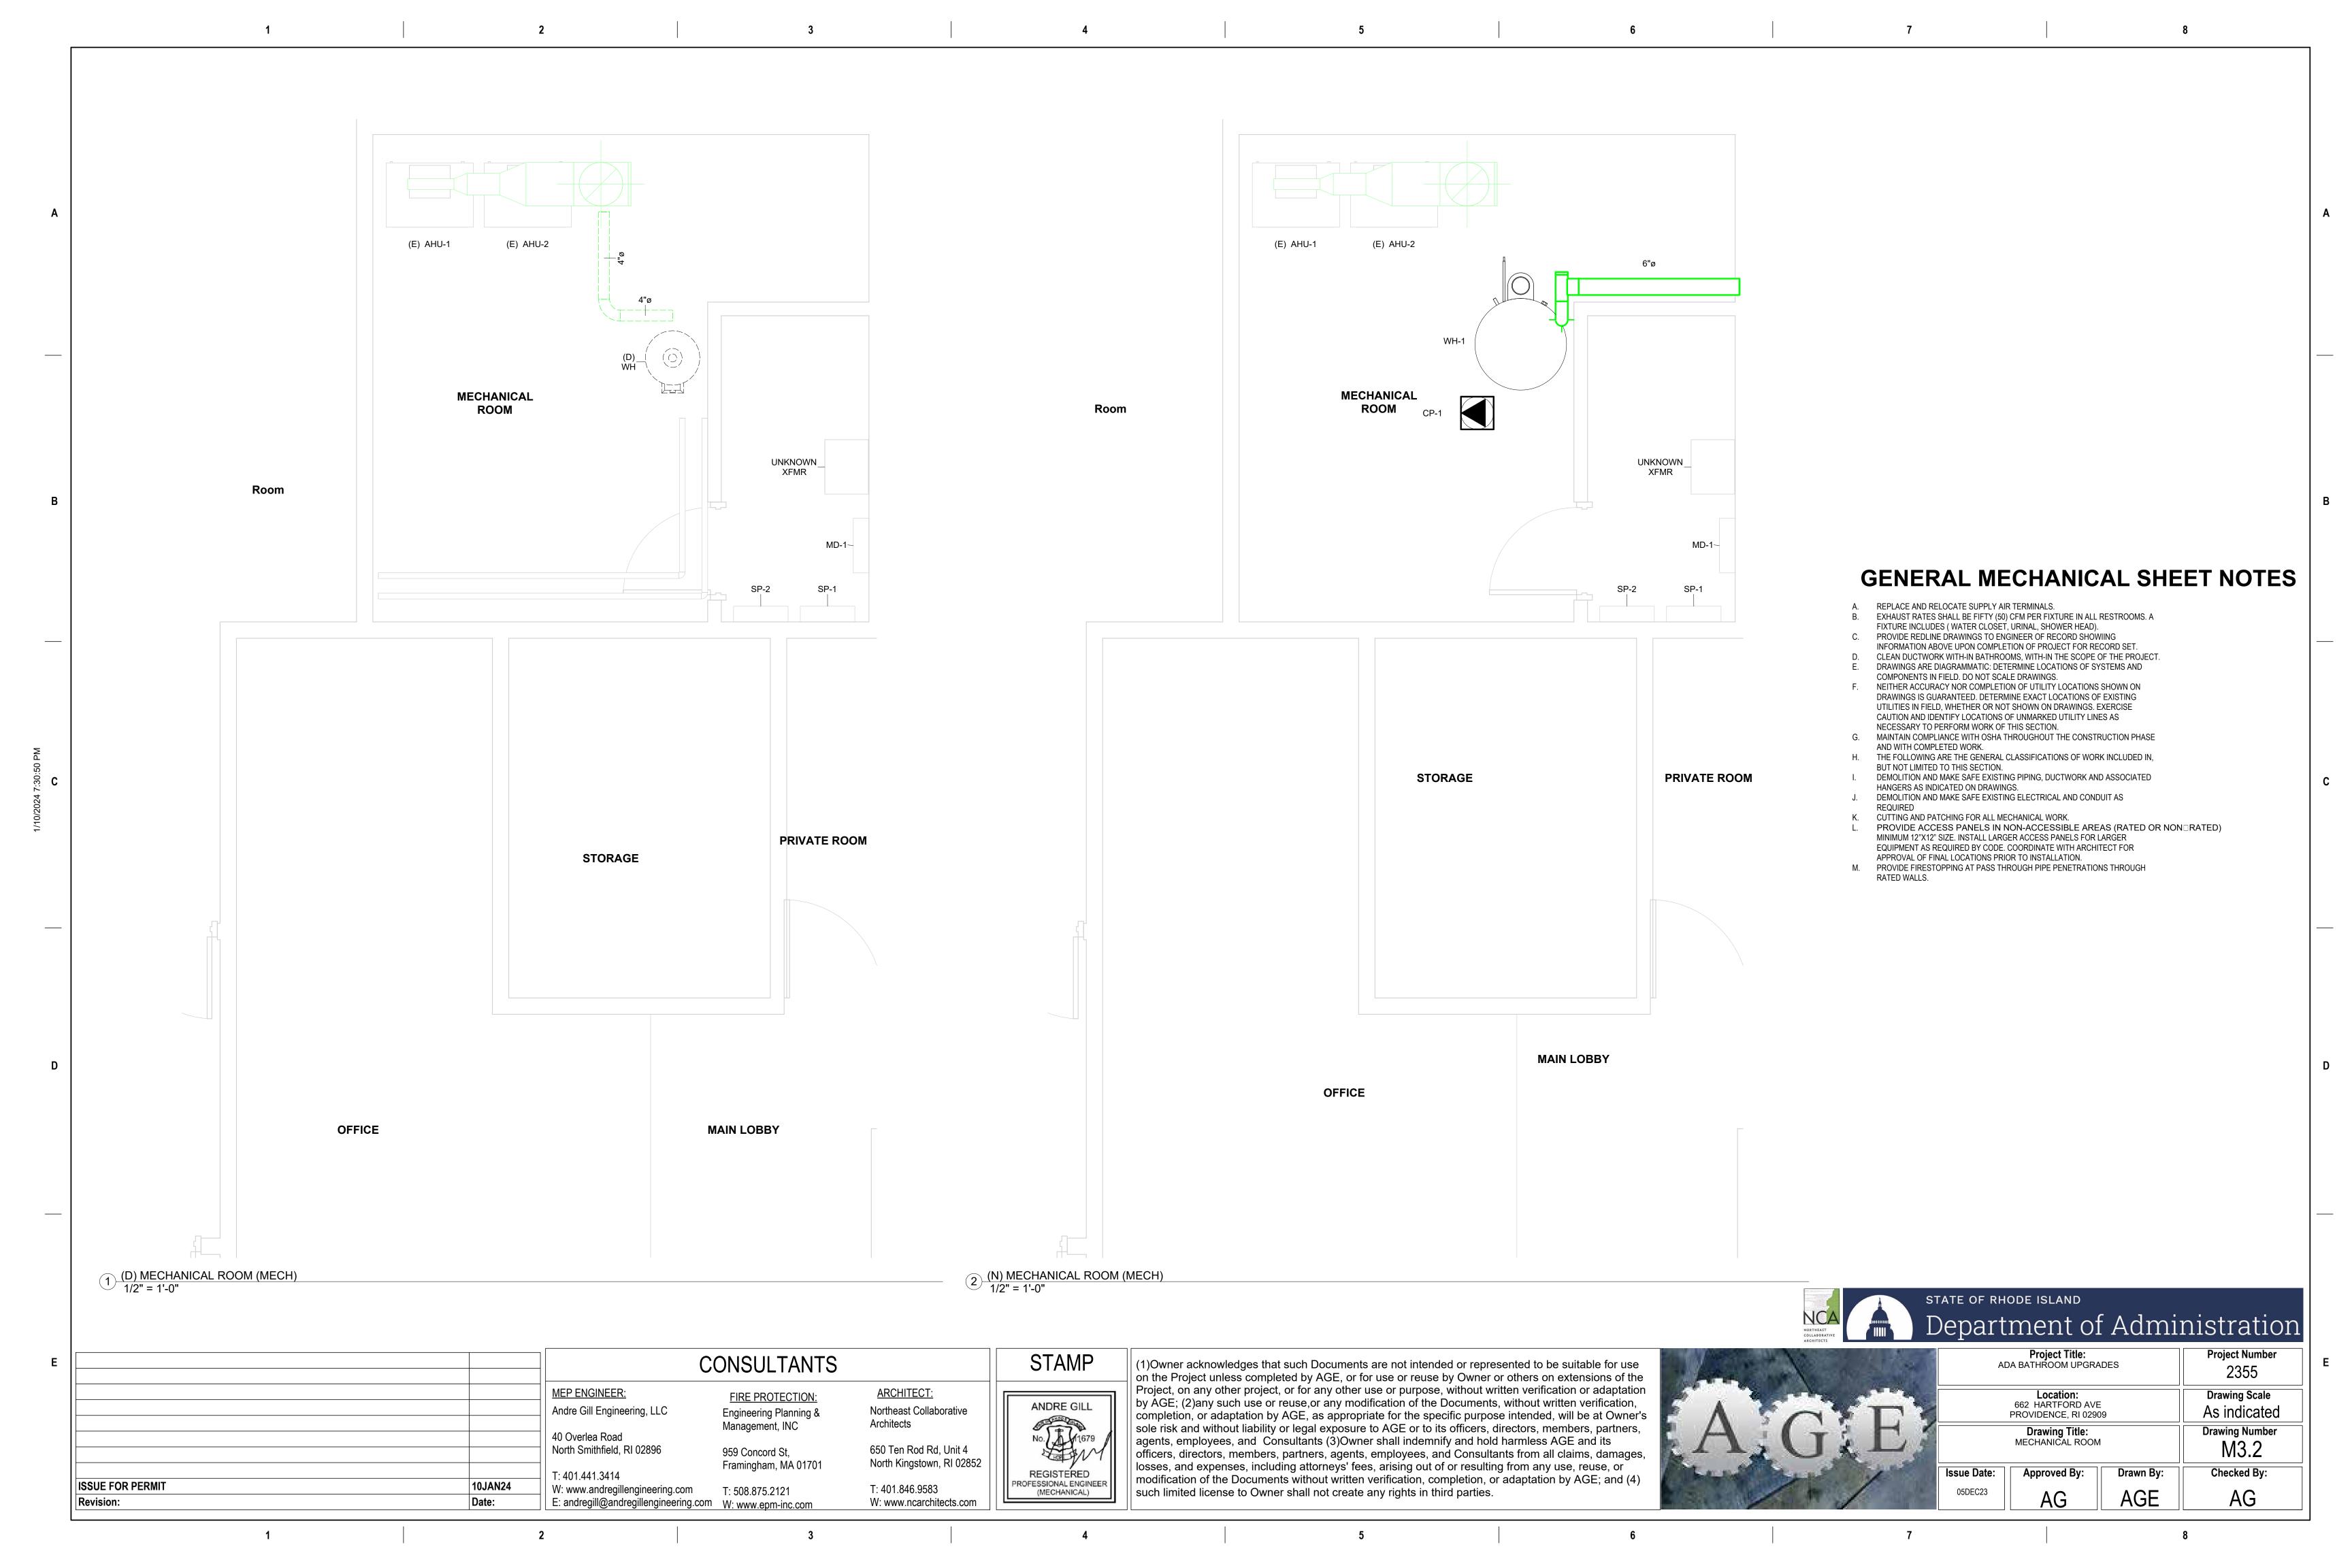VIBRATION ISOLATION KIT, HANGING FOR MODELS SP/CSP, PN VI KIT-SP/CSP

DEHUMIDISTAT, 120V/ 3 AMP, PN 385364

GREENHECK

SP-A390-QD

Job Name: Mark: Submitted By: Date: 12/04/2023

Ceiling Exhaust Fan, Product # SP-A390-QD, 279-410 CFM



Model SP-A direct drive, ceiling mounted fan is designed to provide the lowest sounds levels for bathroom exhaust. Units feature an insulated housing and are ideal for residential, multi-family or hotel applications.

- Acoustic insulation absorbs sound ensuring quiet operation
- Spring loaded aluminum backdraft damper eliminates rattling
- External electrical access reduces installation time
- Speed controllable
- Designer grille included

14 in 11.875 in 11.25 in 8 in 8 in

Certifications

AMCA Air & Sound

UL/cUL 507

GREENHECK

SP-A110-QD

Job Name: Mark: Submitted By: Date: 12/04/2023


Bathroom Exhaust Fan, Product # SP-A110-QD, 98-130 CFM



- Motion and humidity sensing grille options
- available
- Acoustic insulation absorbs sound ensuring quiet operation
- ENERGY STAR rated
- External electrical access reduces installation
- Industry leading low sound levels
- Speed controllable
- Spring loaded aluminum backdraft damper eliminates rattling
- Designer grille included

Certifications

AMCA Air & Sound UL/cUL 507

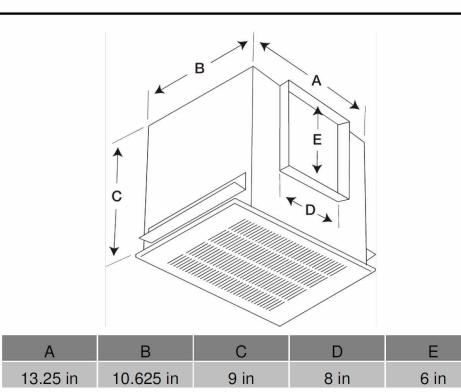

	CONSULTANTS	
MEP ENGINEER:	FIRE PROTECTION:	ARCHITECT:
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NORTHEAST COLLABORATIVE ARCHITECTS)epart	ment of	Admi	nistration
	AI	Project Title: DA BATHROOM UPGRA	DES	Project Number 2355
	Location: 662 HARTFORD AVE PROVIDENCE, RI 02909			Drawing Scale
ALULE	ı	Drawing Title: MECHANICAL SCHEDU	Drawing Number M5.00	
The said of the sa	Issue Date:	Approved By:	Checked By:	
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STATE OF RHODE ISLAND

959 Concord St, Framingham, MA 01701

T: 401.846.9583 W: www.ncarchitects.com

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PLUMBING SCOPE OF WORK

GENERAL NOTES

- PRIOR TO COMMENCING WORK CONTRACTOR SHALL VERIFY EXACT LOCATION OF DOMESTIC WATER, VENT AND DEPTH OF EXISTING SEWER LINES IN THE FIELD.
- ALL PIPING SHALL BE IDENTIFIED ON REDLINE DRAWINGS TO BE PROVIDED BY CONTRACTOR TO ENGINEER, OWNER AND ARCHITECT. INCLUDING SIZE, INVERT ELEVATIONS, DIRECTION OF FLOW PROVIDE ALL MATERIALS AND EQUIPMENT AND PERFORM ALL LABOR REQUIRED TO INSTALL COMPLETE AND OPERABLE MECHANICAL SYSTEMS AS INDICATED ON THE DRAWINGS, AS SPECIFIED AND AS REQUIRED BY
- CONTRACT DOCUMENT DRAWINGS FOR MECHANICAL WORK (HVAC, PLUMBING, AND FIRE PROTECTION) ARE DIAGRAMMATIC AND ARE INTENDED TO CONVEY SCOPE AND GENERAL ARRANGEMENT ONLY. INSTALL ALL MECHANICAL EQUIPMENT AND APPURTENANCES IN ACCORDANCE WITH MANUFACTURERS
- RECOMMENDATIONS, CONTRACT DOCUMENTS, AND APPLICABLE CODES AND REGULATIONS.
- ALL PIPING ON THIS PLAN SHALL BE CONCEALED UNLESS OTHERWISE NOTED.
- REPAIR PAVING/FLOOR AFTER INSTALLATION AND INSPECTION OF UTILITIES INSTALLED. PAINT FLOOR TO MATCH PREVIOUS OR MATCH AND COMPLY WITH ARCHITECTURAL DRAWINGS.
- CONTRACTOR TO RECONNECT EXISTING ELECTRICAL GROUNDING/BONDING TO COLD WATER PIPING SYSTEM. PROVIDE VIBRATION ISOLATION FOR ALL MECHANICAL EQUIPMENT TO PREVENT TRANSMISSION OF VIBRATION TO BUILDING STRUCTURE.
- PROVIDE VIBRATION ISOLATORS FOR ALL PIPING SUPPORTS CONNECTED TO AND WITHIN 50 FEET OF ISOLATED EQUIPMENT (EXCEPT AT BASE ELBOW SUPPORTS AND ANCHOR POINTS) THROUGHOUT MECHANICAL EQUIPMENT ROOMS. DO THE SAME FOR SUPPORTS OF STEAM MAINS WITHIN 50 FEET OF BOILER OR PRESSURE REDUCING VALVES
- PROVIDE VIBRATION ISOLATORS FOR ALL PIPING SUPPORTS OF STEAM MAINS WITHIN 50 FEET OF BOILERS AND PRESSURE REDUCING VALVES.
- THE LOCATION OF EXISTING UNDERGROUND/UNDERSLAB UTILITIES IS SHOWN IN AN APPROXIMATE WAY ONLY. THE CONTRACTOR SHALL DETERMINE THE EXACT LOCATION OF ALL EXISTING UTILITIES BEFORE COMMENCING WORK. THE CONTRACTOR SHALL PAY FOR AND REPAIR ALL DAMAGES CAUSED BY FAILURE TO EXACTLY LOCATE AND PRESERVE ANY AND ALL UNDERGROUND UTILITIES UNLESS OTHERWISE INDICATED.
- COORDINATE CONSTRUCTION OF ALL MECHANICAL WORK WITH ARCHITECTURAL, STRUCTURAL, CIVIL, ELECTRICAL WORK, ETC., SHOWN ON OTHER CONTRACT DOCUMENT DRAWINGS.
- MAINTAIN A MINIMUM OF 6'-8" CLEARANCE TO UNDERSIDE OF PIPES, DUCTS, CONDUITS, SUSPENDED EQUIPMENT. ETC., THROUGHOUT ACCESS ROUTES IN MECHANICAL ROOMS.
- ALL TESTS SHALL BE COMPLETED BEFORE ANY MECHANICAL EQUIPMENT OR PIPING INSULATION IS APPLIED. LOCATE ALL TEMPERATURE, PRESSURE, AND FLOW MEASURING DEVICES IN ACCESSIBLE LOCATIONS WITH STRAIGHT SECTION OF PIPE OR DUCT UP- AND DOWNSTREAM AS RECOMMENDED BY THE MANUFACTURER
- FOR GOOD ACCURACY. PROVIDE ACCESS PANELS WHERE REQUIRED. TESTING, ADJUSTING, AND BALANCING AGENCY SHALL BE A MEMBER OF THE ASSOCIATED AIR BALANCE COUNCIL (AABC) OR THE NATIONAL ENVIRONMENTAL BALANCING BUREAU (NEBB). TESTING, ADJUSTING, AND
- BALANCING SHALL BE PERFORMED IN ACCORDANCE WITH THE AABC STANDARDS WHERE TWO OR MORE ITEMS OF THE SAME TYPE OF EQUIPMENT ARE REQUIRED, THE PRODUCT OF ONE
- MANUFACTURER SHALL BE USED. REINFORCEMENT, DETAILING, AND PLACEMENT OF CONCRETE SHALL CONFORM TO ASTM 315 AND ACI 318. CONCRETE SHALL CONFORM TO ASTM C94. CONCRETE WORK SHALL CONFORM TO ACI 318. PART ENTITLED
- "CONSTRUCTION REQUIREMENTS." COMPRESSIVE STRENGTH IN 28 DAYS SHALL BE 3,000 PSI. TOTAL AIR CONTENT OF EXTERIOR CONCRETE SHALL BE BETWEEN 5 AND 7 PERCENT BY VOLUME. SLUMP SHALL BE BETWEEN 3 AND 4 INCHES. CONCRETE SHALL BE CURED FOR 7 DAYS AFTER PLACEMENT. COORDINATE ALL EQUIPMENT CONNECTIONS WITH MANUFACTURERS 'CERTIFIED DRAWINGS. COORDINATE AND PROVIDE ALL DUCT AND PIPING TRANSITIONS REQUIRED FOR FINAL FOLIPMENT CONNECTIONS TO
- FURNISHED EQUIPMENT. FIELD VERIFY AND COORDINATE ALL DUCT AND PIPING DIMENSIONS BEFORE FABRICATION.
- ALL CONTROL WIRE AND CONDUIT SHALL COMPLY WITH THE NATIONAL ELECTRIC CODE AND DIVISION 16 OF
- Q. CONCRETE HOUSEKEEPING PADS TO SUIT MECHANICAL EQUIPMENT SHALL BE SIZED AND LOCATED BY THE MECHANICAL CONTRACTOR. MINIMUM CONCRETE PAD THICKNESS SHALL BE 6 INCHES. PAD SHALL EXTEND BEYOND THE EQUIPMENT A MINIMUM OF 6 INCHES ON EACH SIDE. CONCRETE HOUSEKEEPING PADS SHALL BE PROVIDED BY THE GENERAL CONTRACTOR. IT SHALL BE THE RESPONSIBILITY OF THE MECHANICAL CONTRACTOR TO COORDINATE SIZE AND LOCATION OF CONCRETE HOUSEKEEPING PADS WITH GENERAL CONTRACTOR.
- ALL MECHANICAL ROOM DOORS SHALL BE A MINIMUM OF 4 '-0" WIDE.
- WHERE BEAMS ARE INDICATED TO BE PENETRATED WITH DUCTWORK OR PIPING, COORDINATE DUCTWORK AND PIPING LAYOUT WITH BEAM OPENING SIZE AND OPENING LOCATIONS. COORDINATION SHALL BE DONE PRIOR TO FABRICATION OF DUCTWORK, CUTTING OF PIPING, OR FABRICATION OF BEAMS.
- WHEN MECHANICAL WORK (HVAC, PLUMBING, SHEET METAL, FIRE PROTECTION, ETC.) IS SUBCONTRACTED, IT SHALL BE THE MECHANICAL CONTRACTOR'S RESPONSIBILITY TO COORDINATE SUBCONTRACTORS AND THE ASSOCIATED CONTRACTS. WHEN DISCREPANCIES ARISE PERTAINING TO WHICH CONTRACTOR PROVIDES A PARTICULAR ITEM OF THE MECHANICAL CONTRACT OR WHICH CONTRACTOR PROVIDES FINAL CONNECTIONS FOR A PARTICULAR ITEM OF THE MECHANICAL CONTRACT, IT SHALL BE BROUGHT TO THE ATTENTION OF THE MECHANICAL CONTRACTOR, WHOSE DECISION SHALL BE FINAL.
- THE LOCATIONS OF ALL ITEMS SHOWN ON THE DRAWINGS OR CALLED FOR IN THE SPECIFICATIONS THAT ARE NOT DEFINITELY FIXED BY DIMENSIONS ARE APPROXIMATE ONLY. THE EXACT LOCATIONS NECESSARY TO SECURE THE BEST CONDITIONS AND RESULTS MUST BE DETERMINED BY THE PROJECT SITE CONDITIONS AND SHALL HAVE THE APPROVAL OF THE ENGINEER BEFORE BEING INSTALLED. DO NOT SCALE DRAWINGS.
- ALL MISCELLANEOUS STEEL REQUIRED TO ENSURE PROPER INSTALLATION AND AS SHOWN IN DETAILS FOR PIPING, DUCTWORK, AND EQUIPMENT (UNLESS OTHERWISE NOTED) SHALL BE FURNISHED AND INSTALLED BY
- PROVIDE ACCESS PANELS FOR INSTALLATION IN WALLS AND CEILINGS, WHERE REQUIRED, TO SERVICE DAMPERS, VALVES, SMOKE DETECTORS, AND OTHER CONCEALED MECHANICAL EQUIPMENT. ACCESS PANELS SHALL BE TURNED OVER TO GENERAL CONTRACTOR FOR INSTALLATION.
- AC. ALL EQUIPMENT, PIPING, DUCTWORK, ETC., SHALL BE SUPPORTED AS DETAILED, SPECIFIED, AND REQUIRED TO PROVIDE A VIBRATION FREE INSTALLATION.
- AD. ALL DUCTWORK, PIPING AND EQUIPMENT SUPPORTED FROM STRUCTURAL STEEL SHALL BE COORDINATED
- WITH GENERAL CONTRACTOR. ALL ATTACHMENTS TO STEEL BAR JOISTS, TRUSSES, OR JOIST GIRDERS SHALL BE AT PANEL POINTS. PROVIDE BEAM CLAMPS MEETING MSS STANDARDS.
- WELDING TO STRUCTURAL MEMBERS SHALL NOT BE PERMITTED. THE USE OF C-CLAMPS SHALL NOT BE
- MECHANICAL EQUIPMENT, DUCTWORK, AND PIPING SHALL NOT BE SUPPORTED FROM METAL DECK. ALL ROOF MOUNTED EQUIPMENT CURBS FOR EQUIPMENT PROVIDED BY THE MECHANICAL CONTRACTOR
- SHALL BE FURNISHED BY THE MECHANICAL CONTRACTOR AND INSTALLED BY THE GENERAL CONTRACTOR. LOCATIONS AND SIZES OF ALL FLOOR, WALL, AND ROOF OPENINGS SHALL BE COORDINATED WITH ALL OTHER TRADES INVOLVED
- ALL OPENINGS IN FIRE WALLS DUE TO DUCTWORK, PIPING, CONDUIT, ETC., SHALL BE FIRE STOPPED WITH A PRODUCT SIMILAR TO 3M OR APPROVED EQUAL.
- ALL AIR CONDITIONING CONDENSATE DRAIN LINES FROM EACH AIR HANDLING UNIT AND ROOFTOP UNIT SHALL BE PIPED FULL SIZE OF THE UNIT DRAIN OUTLET, WITH "P" TRAP, AND PIPED TO NEAREST DRAIN. SEE DETAILS SHOWN ON THE DRAWINGS OR THE CONTRACT SPECIFICATIONS FOR DEPTH OF AIR CONDITIONING CONDENSATE TRAP
- AK. REFER TO TYPICAL DETAILS FOR DUCTWORK, PIPING, AND EQUIPMENT INSTALLATION.

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PIPING NOTES

- PROVIDE ALL MATERIALS AND EQUIPMENT AND PERFORM ALL LABOR REQUIRED TO INSTALL COMPLETE AND OPERABLE PIPING SYSTEMS AS INDICATED ON THE DRAWINGS, AS SPECIFIED AND AS REQUIRED BY CODE.
- ELEVATIONS AS SHOWN ON THE DRAWINGS ARE TO THE CENTERLINE OF ALL PRESSURE PIPING AND TO THE
- MAINTAIN A MINIMUM OF 3'6" OF GROUND COVER OVER ALL UNDERGROUND HVAC PIPING BUT ENSURE FROST LINE IN CONSIDERED AND MET.
- UNLESS OTHERWISE NOTED, ALL CHILLED WATER AND HEATING WATER PIPING SHALL BE 3 /4 INCH SIZE (EDIT SYSTEM TYPE OR PIPE SIZE TO SUIT PROJECT REQUIREMENTS).
- PROVIDE AN AIR VENT AT THE HIGH POINT OF EACH DROP ALL HYDRONIC PIPING SYSTEMS INCLUDING BUT NOT LIMITED TO IN THE HEATING WATER, CHILLED WATER, AND OTHER CLOSED WATER PIPING SYSTEMS (EDIT SYSTEM TYPES TO SUIT PROJECT REQUIREMENTS). ALL PIPING SHALL GRADE TO LOW POINTS. PROVIDE HOSE
- END DRAIN VALVES AT THE BOTTOM OF ALL RISERS AND LOW POINTS. UNLESS OTHERWISE NOTED, ALL PIPING IS OVERHEAD, TIGHT TO UNDERSIDE OF STRUCTURE OR SLAB, WITH
- SPACE FOR INSULATION IF REQUIRED. INSTALL PIPING SO THAT ALL VALVES, STRAINERS, UNIONS, TRAPS, FLANGES, AND OTHER APPURTENANCES
- REQUIRING ACCESS ARE ACCESSIBLE. ALL VALVES SHALL BE INSTALLED SO THAT VALVE REMAINS IN SERVICE WHEN EQUIPMENT OR PIPING ON EQUIPMENT SIDE OF VALVE IS REMOVED.
- ALL BALANCING VALVES AND BUTTERFLY VALVES SHALL BE PROVIDED WITH POSITION INDICATORS AND MAXIMUM ADJUSTABLE STOPS (MEMORY STOPS)
- PROVIDE CHAINWHEEL OPERATORS FOR ALL VALVES IN EQUIPMENT ROOMS MOUNTED GREATER THAN 7 '-0" ABOVE FLOOR LEVEL; CHAIN SHALL EXTEND TO 7 '-0" ABOVE FLOOR LEVEL.
- ALL VALVES (EXCEPT CONTROL VALVES) AND STRAINERS SHALL BE FULL SIZE OF PIPE BEFORE REDUCING SIZE TO MAKE CONNECTIONS TO EQUIPMENT AND CONTROLS.
- UNIONS AND/OR FLANGES SHALL BE INSTALLED AT EACH PIECE OF EQUIPMENT, IN BYPASSES, AND IN LONG PIPING RUNS (100 FEET OR MORE) TO PERMIT DISASSEMBLY FOR ALTERATION AND REPAIRS. PITCH STEAM PIPING DOWNWARD IN THE DIRECTION OF FLOW 1 /4 INCH IN 10 FEET (1 INCH IN 40 FEET) MINIMUM. PITCH ALL STEAM RETURN LINES DOWNWARD IN THE DIRECTION OF CONDENSATE FLOW 1 /2 INCH PER 10 FEET (1
- TOWARD MAINS 1/2 INCH PER FOOT MINIMUM. PITCH UP ALL STEAM AND CONDENSATE RUNOUTS TO RISERS AND EQUIPMENT 1 /2 INCH PER FOOT. WHERE THIS PITCH CANNOT BE OBTAINED, RUNOUTS OVER 8 FEET IN LENGTH SHALL BE ONE SIZE LARGER THAN NOTED.

INCH IN 20 FEET) MINIMUM. WHERE LENGTH OF BRANCH LINES ARE LESS THAN 8 FEET, PITCH BRANCH LINES

- TAP ALL BRANCH LINES FROM TOP OF STEAM MAINS (45 DEGREES PREFERRED, 90 DEGREES ACCEPTABLE) PROVIDE AN END OF MAIN DRIP AT EACH RISE IN THE STEAM MAIN. PROVIDE CONDENSATE DRIPS AT THE BOTTOM OF ALL STEAM RISERS, DOWNFED RUNOUTS TO EQUIPMENT, RADIATORS, ETC., AT END OF MAINS AND LOW POINTS, AND AHEAD OF ALL PRESSURE REGULATORS, CONTROL VALVES, ISOLATION VALVES, AND
- Q. ON STRAIGHT STEAM PIPING RUNS WITH NO NATURAL DRAINAGE POINTS, INSTALL DRIP LEGS AT INTERVALS NOT EXCEEDING 200 FEET WHERE PIPE IS PITCHED DOWNWARD IN THE DIRECTION OF STEAM FLOW AND A MAXIMUM OF 100 FEET WHERE THE PIPE IS PITCHED UP SO THAT CONDENSATE FLOW IS OPPOSITE OF STEAM FLOW.
- STEAM TRAPS SHALL BE MINIMUM 3/4" SIZE.

EXPANSION JOINTS.

- INSTALL ALL PIPING WITHOUT FORCING OR SPRINGING.
- ALL PIPING SHALL CLEAR DOORS AND WINDOWS. ALL VALVES SHALL BE ADJUSTED FOR SMOOTH AND EASY OPERATION.
- ALL PIPING WORK SHALL BE COORDINATED WITH ALL TRADES INVOLVED. OFFSETS IN PIPING AROUND
- OBSTRUCTIONS SHALL BE PROVIDED AT NO ADDITIONAL COST TO THE OWNER. PROVIDE FLEXIBLE CONNECTIONS IN ALL PIPING SYSTEMS CONNECTED TO PUMPS, CHILLERS, COOLING
- TOWERS, AND OTHER EQUIPMENT WHICH REQUIRE VIBRATION ISOLATION EXCEPT WATER COILS. FLEXIBLE CONNECTIONS SHALL BE PROVIDED AS CLOSE TO THE EQUIPMENT AS POSSIBLE OR AS INDICATED ON THE
- DRAWINGS X. SLOPE REFRIGERANT PIPING ONE PERCENT IN THE DIRECTION OF OIL RETURN. LIQUID LINES MAY BE INSTALLED
- INSTALL HORIZONTAL REFRIGERANT HOT GAS DISCHARGE PIPING WITH 1 /2" PER 10 FEET DOWNWARD SLOPE AWAY FROM THE COMPRESSOR.Z. INSTALL HORIZONTAL REFRIGERANT SUCTION LINES WITH 1 /2" PER 10 FEET DOWNWARD SLOPE TO THE COMPRESSOR, WITH NO LONG TRAPS OR DEAD ENDS WHICH MAY CAUSE OIL TO
- SEPARATE FROM THE SUCTION GAS AND RETURN TO THE COMPRESSOR IN DAMAGING SLUGS. PROVIDE LINE SIZE LIQUID INDICATORS IN MAIN LIQUID LINE LEAVING CONDENSER OR RECEIVER. INSTALL MOISTURE-LIQUID INDICATORS IN LIQUID LINES BETWEEN FILTER DRYERS AND THERMOSTATIC EXPANSION
- VALVES AND IN LIQUID LINE TO RECEIVER. AA. PROVIDE LINE SIZE STRAINER UPSTREAM OF EACH AUTOMATIC VALVE. PROVIDE SHUTOFF VALVE ON EACH SIDE
- OF STRAINER. AB. PROVIDE PERMANENT FILTER DRYERS IN LOW TEMPERATURE SYSTEMS AND SYSTEMS USING HERMETIC
- COMPRESSORS AC. PROVIDE REPLACEABLE CARTRIDGE FILTER DRYERS WITH THREE VALVE BYPASS ASSEMBLY FOR SOLENOID
- VALVES, ADJACENT TO RECEIVERS. AD. PROVIDE REFRIGERANT CHARGING VALVE CONNECTIONS IN LIQUID LINE BETWEEN RECEIVER SHUTOFF VALVE AND EXPANSION VALVE

ENGINEER'S STATEMENT

ENGINEER OF RECORD (EOR) ANDRE GILL ENGINEERING, LLC (AGE) WAS HIRED BY RGB ARCHITECTS TO PROVIDE PLUMBING AND VENT LOAD CALCULATIONS TO SIZE LINES, SELECT AND SPECIFY EQUIPMENT TO BE INSTALLED BY THE SUCCESSFUL CONTRACTOR FOR WORK DESCRIBED IN THE PROJECT SCOPE

DEMO NOTES

- PRIOR TO SUBMITTING BID, THE CONTRACTOR SHALL VISIT THE PROJECT SITE TO BECOME FAMILIAR WITH ALL EXISTING CONDITIONS AND TO DETERMINE THE EXTENT OF WORK TO REMOVE THE EXISTING PLUMBING SYSTEM INDICATED TO BE REMOVED. REQUEST FOR COMPENSATION FOR EXTRA WORK. WHICH WOULD HAVE BEEN EVIDENT BY COMPLIANCE WITH THE PREVIOUS STATEMENT. WILL NOT BE
- CONSIDERED. EXISTING CONDITIONS INFORMATION SHOWN AND/OR INDICATED ON THE DRAWINGS WERE OBTAINED FROM LIMITED EXISTING DRAWINGS PREPARED BY OTHERS; NON-DESTRUCTIVE FIELD INVESTIGATION REVIEW; FIELD MEASUREMENT; OTHER AVAILABLE DOCUMENTATION. NOT ALL EXISTING CONDITIONS &/or
- ACTUAL CONSTRUCTION MAY BE INDICATED AND/OR KNOWN. CONTRACTOR SHALL FIELD VERIFY ALL EXISTING, CONDITIONS, CONNECTIONS, LOCATIONS, SIZES, ETC. IN THE FIELD AND NOTIFY THE ENGINEER OF RECORD OF ANY DISCREPANCIES BEFORE STARTING
- CONTRACTOR SHALL COORDINATE EXTENTS OF ALL DEMOLITION WORK WITH ALL NEW WORK AND NOTIFY THE ARCHITECT AND ENGINEER OF RECORD OF ANY DISCREPANCIES BEFORE STARTING DEMOLITION
- CONTRACTOR SHALL MAKE SAFE AND PROPERLY DE-ENERGIZE, SHUT OFF & CAP ALL UTILITIES
- (ELECTRICAL, GAS, WATER, SEWER, TELEPHONE, ETC.) VERIFY PIPING SERVES ONLY PLUMBING FIXTURES INDICATED FOR DEMOLITION BEFORE SHUT-DOWN FOR DISCONNECTION. IDENTIFY EXISTING PIPING WHICH SERVES FIXTURES TO REMAIN. NOTIFY ARCHITECT OF ACTIVE PIPING TO BE MAINTAINED WHEN LOCATED IN PARTITION TO BE DEMOLISHED.
- COORDINATE ALL SHUT-DOWNS, TIE-INS, ETC., WITH THE G.C. ELECTRICAL MAKE-SAFE OF PLUMBING EQUIPMENT REQUIRING DEMOLITION SHALL BE COMPLETED BY THE ELECTRICAL SUBCONTRACTOR. FULL EXTENT OF MEP MATERIALS ARE UNKNOWN. EXISTING BUILDING CONSTRUCTION MAY CONTAIN
- MATERIALS THAT REQUIRE ABATEMENT. IF POTENTIAL MATERIALS ARE DISCOVERED, CONTRACTOR SHALL NOTIFY OWNER & ARCHITECT BEFORE PROCEEDING WITH WORK. CONTRACTOR SHALL PROTECT ALL EXISTING WORK TO REMAIN DURING DEMOLITION. CONTRACTOR TO FURNISH AND INSTALL ALL SHORING AND/OR BRACING TO SUPPORT ALL EXISTING WALLS, FLOORS/ROOFS, ETC. PRIOR TO REMOVALS OF EXISTING CONSTRUCTION. DEMOLITION SUBCONTRACTOR MUST PROTECT EXISTING SLAB, WALL, FENCING AND BUILDING STRUCTURE DURING

SUBCONTRACTORS EXPENSE. ALL DEMOLITION WORK PERFORMED SHALL BE DONE IN ACCORDANCE WITH

THE APPLICABLE NATIONAL, STATE, AND LOCAL CODES, LAWS AND ORDINANCES. EXISTING DEFICIENCIES NOT INDICATED ON THE DRAWINGS, BUT UNCOVERED AND/OR DISCOVERED BY CONTRACTOR'S CONSTRUCTION ACTIVITIES SHALL BE REPORTED TO THE ENGINEER OF RECORD FOR REVIEW PRIOR TO INSTALLATION OF NEW WORK. ADDITIONAL DETAILS WILL BE FURNISHED AS

DEMOLITION PHASE. DAMAGE TO EXISTING STRUCTURE SHALL BE REPAIRED AT DEMOLITION

PLUMBING

- GENERAL NOTES, SYMBOLS LIST AND DETAILS ARE APPLICABLE TO ALL PLUMBING DRAWINGS. B. DRAWINGS ARE DIAGRAMMATIC: DETERMINE LOCATIONS OF SYSTEMS AND COMPONENTS IN FIELD. DO
- NEITHER ACCURACY NOR COMPLETION OF UTILITY LOCATIONS SHOWN ON DRAWINGS IS GUARANTEED. DETERMINE EXACT LOCATIONS OF EXISTING UTILITIES IN FIELD, WHETHER OR NOT SHOWN ON DRAWINGS. EXERCISE CAUTION AND IDENTIFY LOCATIONS OF UNMARKED UTILITY LINES AS NECESSARY TO PERFORM
- PROVIDE ALL MATERIALS AND EQUIPMENT AND PERFORM ALL LABOR REQUIRED TO INSTALL COMPLETE AND OPERABLE PLUMBING SYSTEMS AS INDICATED ON THE DRAWINGS, AS SPECIFIED AND AS REQUIRED
- ALL WORK SHALL BE IN ACCORDANCE WITH NATIONAL, STATE AND LOCAL CODES AND ORDINANCES
- HAVING JURISDICTION, AS INTERPRETED BY THE ARCHITECT/ENGINEER. PLUMBING EQUIPMENT AND SUCH OTHER APPARATUS AS MAY REQUIRE MAINTENANCE AND OPERATION FROM TIME TO TIME SHALL BE MADE EASILY ACCESSIBLE. ALTHOUGH THE EQUIPMENT MAY BE SHOWN ON THE DRAWINGS IN CERTAIN LOCATIONS. THE CONSTRUCTION MAY DISCLOSE THAT SUCH LOCATIONS DO NOT MAKE ITS POSITION READILY ACCESSIBLE. IN SUCH CASES, THE OWNER OR THEIR REPRESENTATIVE SHALL BE NOTIFIED BEFORE ADVANCING THE CONSTRUCTION TO A STAGE WHERE A CHANGE WILL
- REFLECT ADDITIONAL EXPENSE. THE DRAWINGS SHOW THE LAYOUT OF THE PLUMBING SYSTEMS AND INDICATE THE APPROXIMATE LOCATIONS OF PIPING, BRANCHES AND ELBOWS, AND EQUIPMENT. THE RUNS AND QUANTITY OF PIPING, OFFSETS AND ELBOWS AS SHOWN ON THE DRAWINGS ARE DIAGRAMMATIC ONLY. THE EXACT ROUTING OF QUANTITY PIPING, OFFSETS AND ELBOWS SHALL BE DETERMINED BY THE STRUCTURAL CONDITIONS, POSSIBLE OBSTRUCTIONS AND COORDINATION DRAWINGS. THIS SHALL NOT BE CONSTRUED TO MEAN THAT THE DESIGN OF THE SYSTEMS MAY BE CHANGED, BUT REFERS ONLY TO EXACT ROUTING BETWEEN
- IT SHALL BE THE RESPONSIBILITY OF THE PLUMBING CONTRACTOR TO STUDY ALL DRAWINGS AND DETAILS SO THAT THE INSTALLATION OF ALL NEW WORK CAN BE FULLY COORDINATED. COORDINATE WITH ALL TRADES TO AVOID INTERFERENCE BETWEEN THE PLUMBING INSTALLATION AND THE SYSTEMS AND
- EQUIPMENT OF OTHER TRADES. PLUMBING WORK IS INDICATED DIAGRAMMATICALLY. EXACT LOCATION OF ALL COMPONENTS ARE TO BE DETERMINED IN THE FIELD AND BY THE ACTUAL BUILDING CONDITIONS. EQUIPMENT OR PIPES INTERFERING WITH OTHER INSTALLATIONS SHALL BE RELOCATED AS REQUIRED AT NO ADDITIONAL COST.
- PLUMBING CONTRACTOR SHALL COORDINATE ALL WALL, CEILING, FLOOR, ROOF AND BEAM PENETRATIONS WITH ARCHITECT AND STRUCTURAL ENGINEER.
- PRODUCTS REQUIRED BY CONSTRUCTION BUT NOT SPECIFICALLY DESCRIBED HEREIN SHALL BE AS SELECTED BY THE CONTRACTOR SUBJECT TO THE APPROVAL OF AGE AND A/E. INSTALLATION OF THE PLUMBING SYSTEM SHALL PERMIT ACCESSIBILITY FOR SERVICE AND/OR
- REPLACEMENT OF EQUIPMENT. RUN ALL SOIL WASTE AND VENT PIPING WITH 2% MINIMUM GRADE UNLESS OTHERWISE NOTED (EDIT SLOPE TO SUIT PROJECT REQUIREMENTS). HORIZONTAL VENT PIPING SHALL BE GRADED TO DRIP BACK
- TO THE SOIL OR WASTE PIPE BY GRAVITY. ELEVATIONS AS SHOWN ON THE DRAWINGS ARE TO THE CENTERLINE OF ALL PRESSURE PIPING AND TO
- THE INVERT OF ALL GRAVITY PIPING. ADJUST SEWER INVERTS TO KEEP TOPS OF PIPE IN LINE WHERE PIPE SIZE CHANGES. MAINTAIN A MINIMUM OF 3 '6" OF GROUND COVER OVER ALL UNDERGROUND WATER MAINS AND A MINIMUM
- OF 3'0" OF GROUND COVER OVER ALL UNDERGROUND SEWERS AND DRAINS ENSURE DEPTH OF GROUND COVER SUIT'S FROST LINE DEPTH AND PROJECT REQUIREMENTS. Q. PROVIDE SHUTOFF VALVES IN ALL DOMESTIC WATER PIPING SYSTEM BRANCHES IN WHICH BRANCH
- PIPING SERVES TWO OR MORE FIXTURES. UNLESS OTHERWISE NOTED, ALL DOMESTIC COLD AND HOT WATER PIPING SHALL BE 1/2 INCH SIZE.
- UNLESS OTHERWISE NOTED, ALL PIPING IS OVERHEAD, TIGHT TO UNDERSIDE OF SLAB, WITH SPACE FOR INSTALL PIPING SO THAT ALL VALVES, STRAINERS, UNIONS, TRAPS, FLANGES, AND OTHER
- APPURTENANCES REQUIRING ACCESS ARE ACCESSIBLE PROVIDE ACCESS PANELS FOR ALL CLEANOUTS, VALVES, ALL OTHER CONCEALED ACCESSORIES REQUIRING ACCESS SUCH AS CONTROL VALVES, PRESSURE REDUCERS, WATER HAMMER ARRESTORS, AND AT ALL OTHER LOCATIONS WHERE COMPONENTS ARE INSTALLED WITHIN TIGHT LOCATIONS
- REQUIRING MAINTENANCE OR ADJUSTING REGARDLESS OF WHETHER OR NOT AN ACCESS IS INDICATED ON THE FLOOR PLANS. WHERE DOMESTIC COLD AND HOT WATER PIPING DROPS INTO A PIPE CHASE, THE SIZE SHOWN FOR THE
- PIPE DROPS SHALL BE USED TO THE LAST FIXTURE. INSTALL ALL PIPING WITHOUT FORCING OR SPRINGING.

FLOORS, ETC

- ALL PIPING SHALL CLEAR DOORS AND WINDOWS. ALL PIPING SHALL GRADE TO LOW POINTS. PROVIDE HOSE END DRAIN VALVES AT THE BOTTOM OF ALL
- RISERS AND LOW POINTS INSTALL ALL PIPING BELOW DUCTWORK UNLESS CLEARANCE CONDITION REQUIRES PIPING TO BE ABOVE. AA. ALL MISCELLANEOUS STRUCTURAL SUPPORTS REQUIRED FOR PIPING EQUIPMENT INSTALLATION SHALL
- BE PROVIDED BY PLUMBING CONTRACTOR. AB. WHERE PIPING PENETRATES ANY SMOKE AND/OR FIRE RATED PARTITIONS PROVIDE UL LISTED FIRE STOP ASSEMBLY TO MAINTAIN RATING OF ASSEMBLY. INSTALL FIRE STOPPING PER MANUFACTURER REQUIREMENTS. ALL FIRE STOPPING TO BE PROVIDED BY A UL CERTIFIED OR MANUFACTURER CERTIFIED
- FIRE STOPPING CONTRACTOR. ALL CEILING MOUNTED EQUIPMENT SHALL BE INSTALLED IN SUCH A WAY THAT LIGHTS, PIPING, AND DUCTWORK DO NOT BLOCK ACCESS TO UNITS AND RELATED ACCESSORIES. AC. THE PLUMBING CONTRACTOR MUST COORDINATE THE COMPONENTS AND PROGRAMMING OF THEIR EQUIPMENT, VENDORS AND THEIR SUBCONTRACTORS. CONTROL SEQUENCES SHALL BE TESTED AND CORRECTED TO THE SATISFACTION OF THE OWNER AND ENGINEER.
- AD. UNIONS AND/OR FLANGES SHALL BE INSTALLED AT EACH PIECE OF EQUIPMENT, IN BYPASSES, AND IN LONG PIPING RUNS (100 FEET OR MORE) TO PERMIT DISASSEMBLY FOR ALTERATION AND REPAIRS. ALL VALVES SHALL BE ADJUSTED FOR SMOOTH AND EASY OPERATION.
- ALL VALVES (EXCEPT CONTROL VALVES) AND STRAINERS SHALL BE FULL SIZE OF PIPE BEFORE REDUCING SIZE TO MAKE CONNECTIONS TO EQUIPMENT AND CONTROLS. PROVIDE CHAINWHEEL OPERATORS FOR ALL VALVES IN EQUIPMENT ROOMS MOUNTED GREATER THAN
- 7'-0" ABOVE FLOOR LEVEL; CHAIN SHALL EXTEND TO 7 '-0" ABOVE FLOOR LEVEL. PROVIDE ALL PLUMBING FIXTURES AND EQUIPMENT WITH ACCESSIBLE STOPS. UNLESS OTHERWISE NOTED, DRAINS SHALL BE INSTALLED AT THE LOW POINT OF ROOFS, AREAWAYS,
- AJ. PROVIDE CLEANOUTS IN SANITARY AND STORM DRAINAGE SYSTEMS AT ENDS OF RUNS, AT CHANGES IN DIRECTION, NEAR THE BASE OF STACKS, EVERY 50 FEET IN HORIZONTAL RUNS AND ELSEWHERE AS INDICATED HORIZONTAL CLEANOUT SPACING TO SUIT CODE AND PROJECT REQUIREMENTS.
- AK. ALL CLEANOUTS SHALL BE FULL SIZE OF PIPE FOR PIPE SIZES 6 INCHES AND SMALLER AND SHALL BE 6 INCHES FOR PIPE SIZES LARGER THAN 6 INCHES AL. ALL BALANCING VALVES AND BUTTERFLY VALVES SHALL BE PROVIDED WITH POSITION INDICATORS AND MAXIMUM ADJUSTABLE STOPS (MEMORY STOPS).
- AM. ALL VALVES SHALL BE INSTALLED SO THAT VALVE REMAINS IN SERVICE WHEN EQUIPMENT OR PIPING ON EQUIPMENT SIDE OF VALVE IS REMOVED. AN. ALL PIPING WORK SHALL BE COORDINATED WITH ALL TRADES INVOLVED. OFFSETS IN PIPING AROUND
- OBSTRUCTIONS SHALL BE PROVIDED AT NO ADDITIONAL COST TO THE OWNER. AO. PROVIDE FLEXIBLE CONNECTIONS IN ALL PIPING SYSTEMS CONNECTED TO PUMPS AND OTHER EQUIPMENT WHICH REQUIRE VIBRATION ISOLATION. FLEXIBLE CONNECTIONS SHALL BE PROVIDED AS
- AP. NEW WATER, WASTE & VENT PIPING SHALL BE HYDROSTATICALLY TESTED IN ACCORDANCE WITH LOCAL PLUMBING INSPECTORS REQUIREMENTS AND AS PER THE STATE PLUMBING CODE. AQ. ALL PLUMBING FIXTURES SHALL BE LISTED AND APPROVED WITH THE APPROPRIATE AHJ.

CLOSE TO THE EQUIPMENT AS POSSIBLE OR AS INDICATED ON THE DRAWINGS.

AR. DETAILS ARE PROVIDED TO AID IN UNDERSTANDING. THEY DO NOT NECESSARILY ILLUSTRATE THE ONLY METHODS OF ACHIEVING CODE COMPLIANCE AND ARE NOT SUBSTITUTES FOR PRODUCT INSTALLATION MANUALS. FURTHERMORE, DETAILS ARE SHOWN FOR TYPICAL CASES AND DO NOT ILLUSTRATE EXACT FIELD CONDITIONS UNLESS INDICATED OTHERWISE.

	PLUMBING- SHEET LIST							
DISCIPLINE	SHEET NUMBER	SHEET NAME	SHEET ISSUE DATE					
PLUMBING	P0.01	PLUMBING GENERAL	10JAN24					
PLUMBING	P1.00	(D) PLUMBING OVERALL	10JAN24					
PLUMBING	P1.01	(N) DOMESTIC PLUMBING OVERALL	10JAN24					
PLUMBING	P1.11	(N) SAN OVERALL PLUMBING	10JAN24					
PLUMBING	P3.00	MAIN BATHROOMS	10JAN24					
PLUMBING	P3.01	STAFF BATHROOMS	10JAN24					
PLUMBING	P3.02	MECHANICAL ROOM	10JAN24					
PLUMBING	P5.00	PLUMBING SCHEDULE	10JAN24					
PLUMBING	P5.01	PLUMBING SCHEDULE	10JAN24					

STATE OF RHODE ISLAND Department of Administration



AΓ	Project Title: DA BATHROOM UPGRA	Project Number 2355
	Location: 662 HARTFORD AVE PROVIDENCE, RI 0290	Drawing Scale 12" = 1'-0"
	Drawing Title: PLUMBING GENERAL	Drawing Number P0.01
Issue Date:	Approved By:	Checked By:
10JAN24	AG	AG

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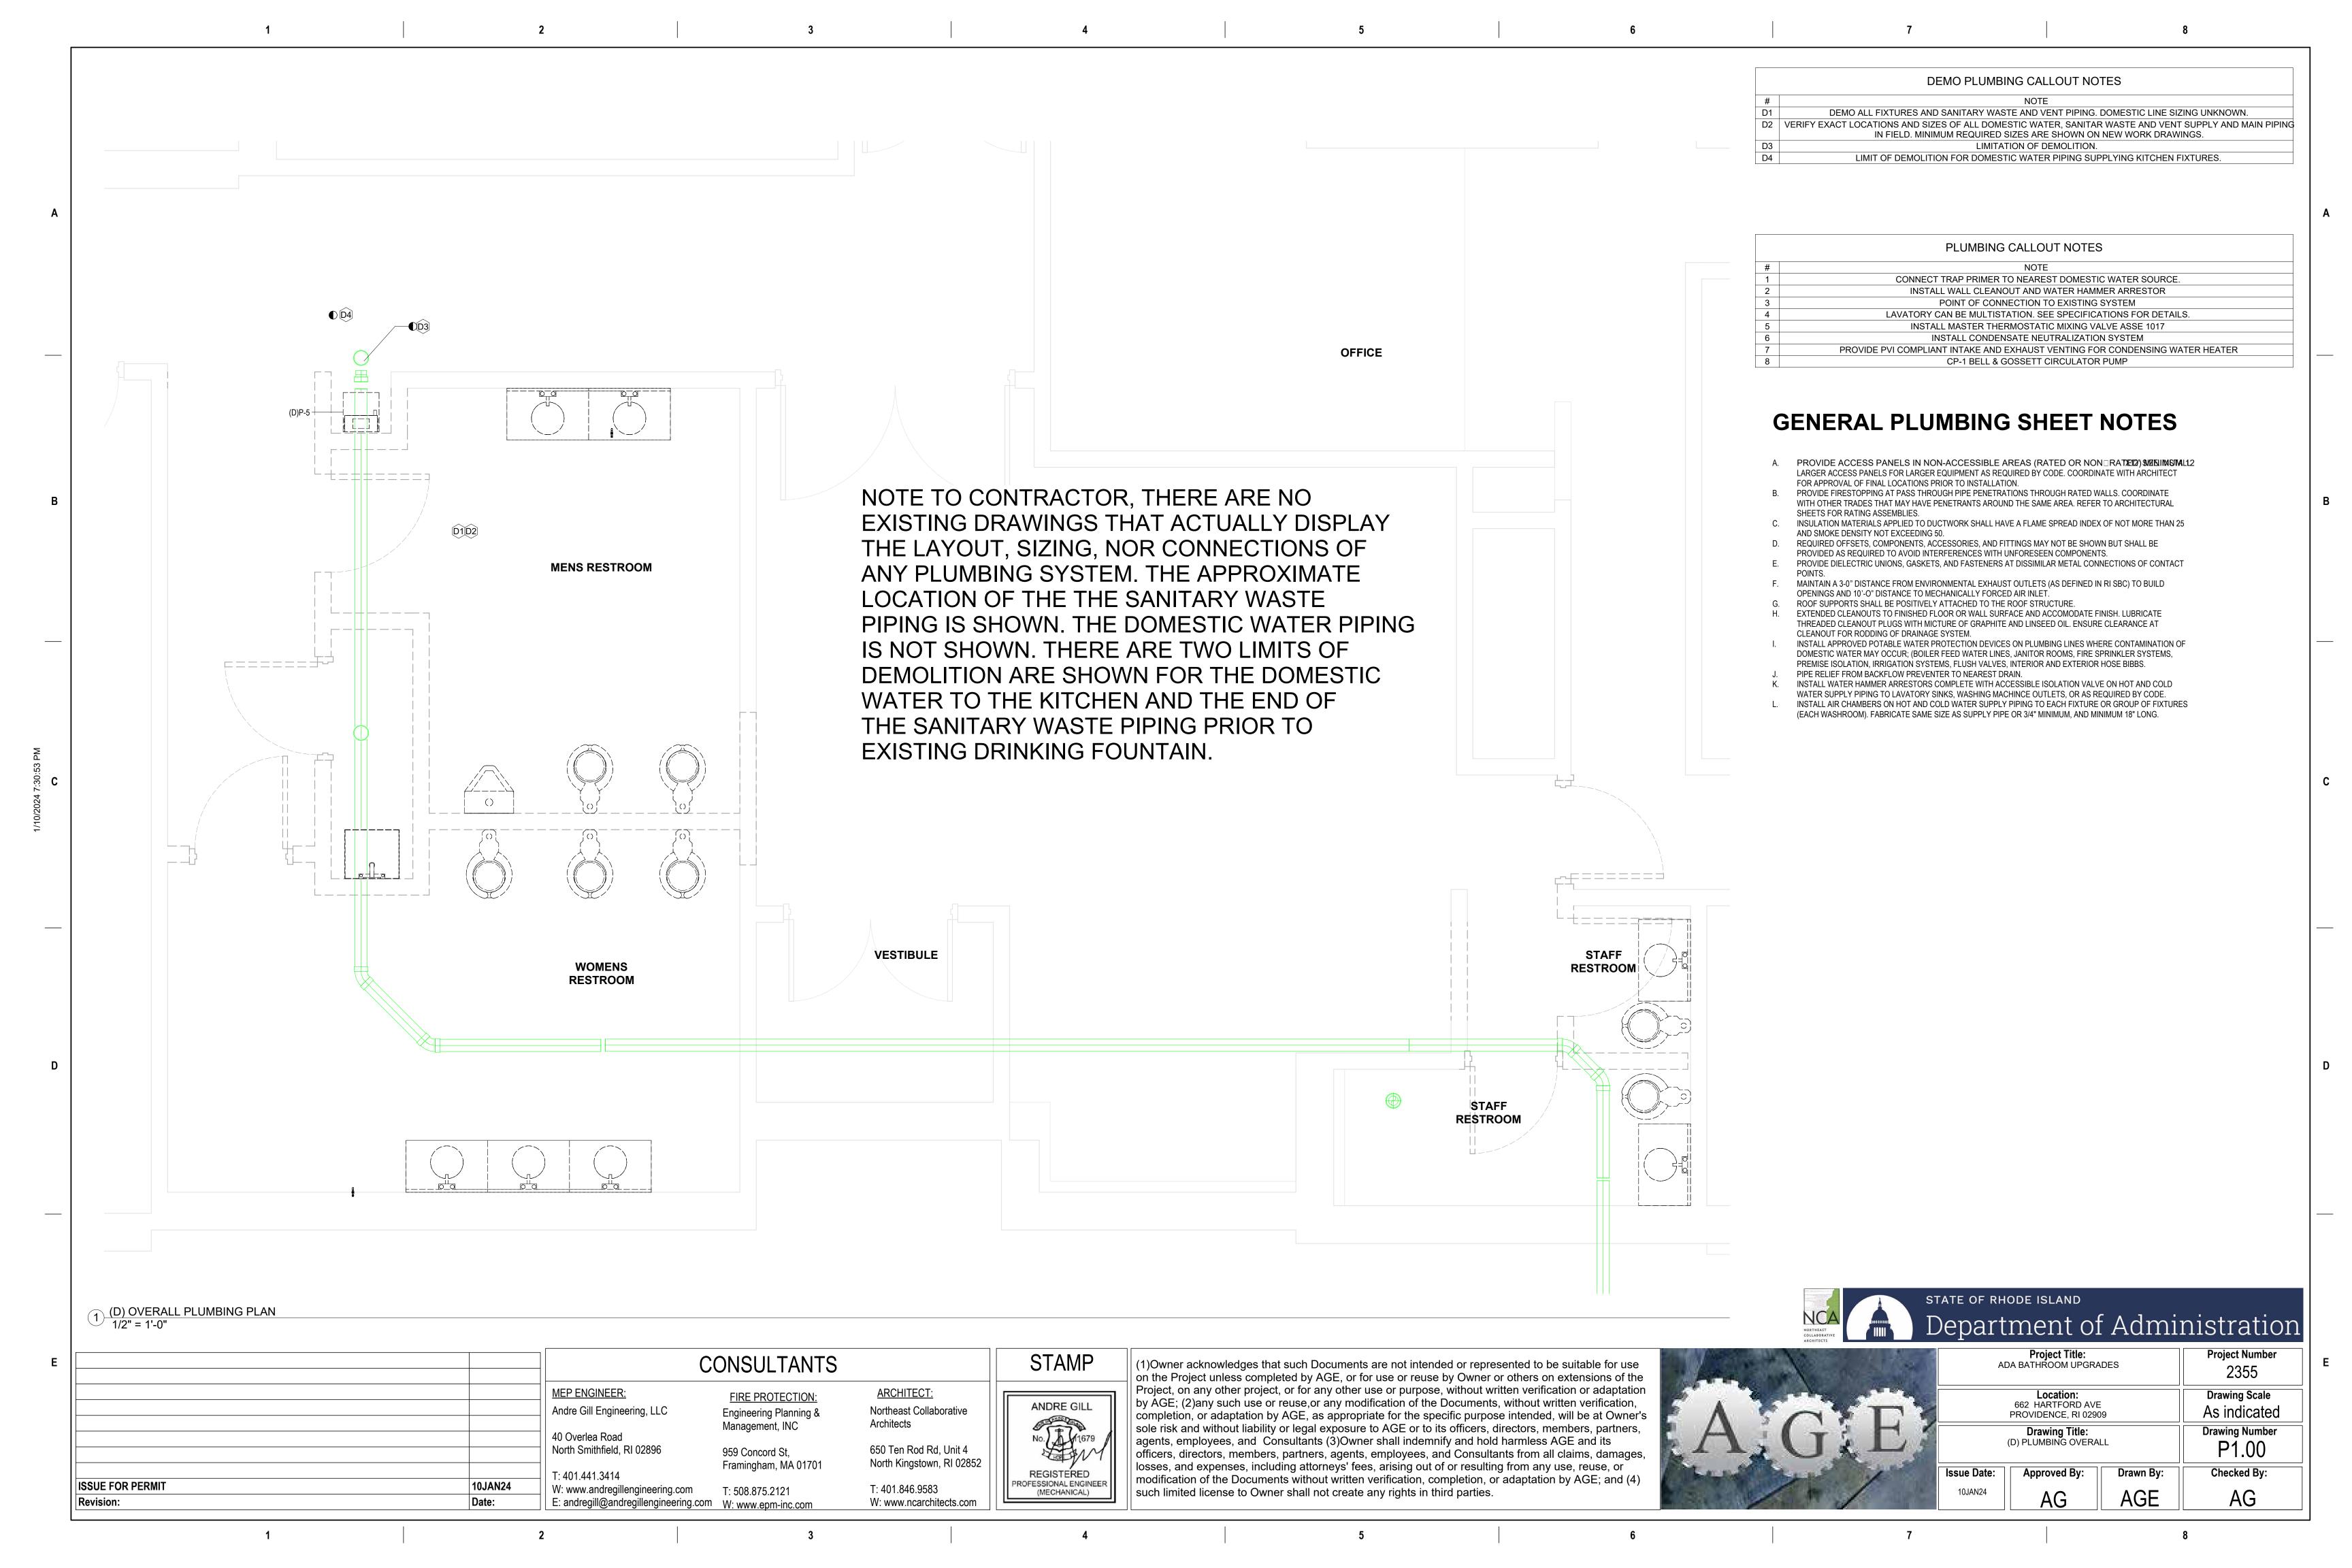
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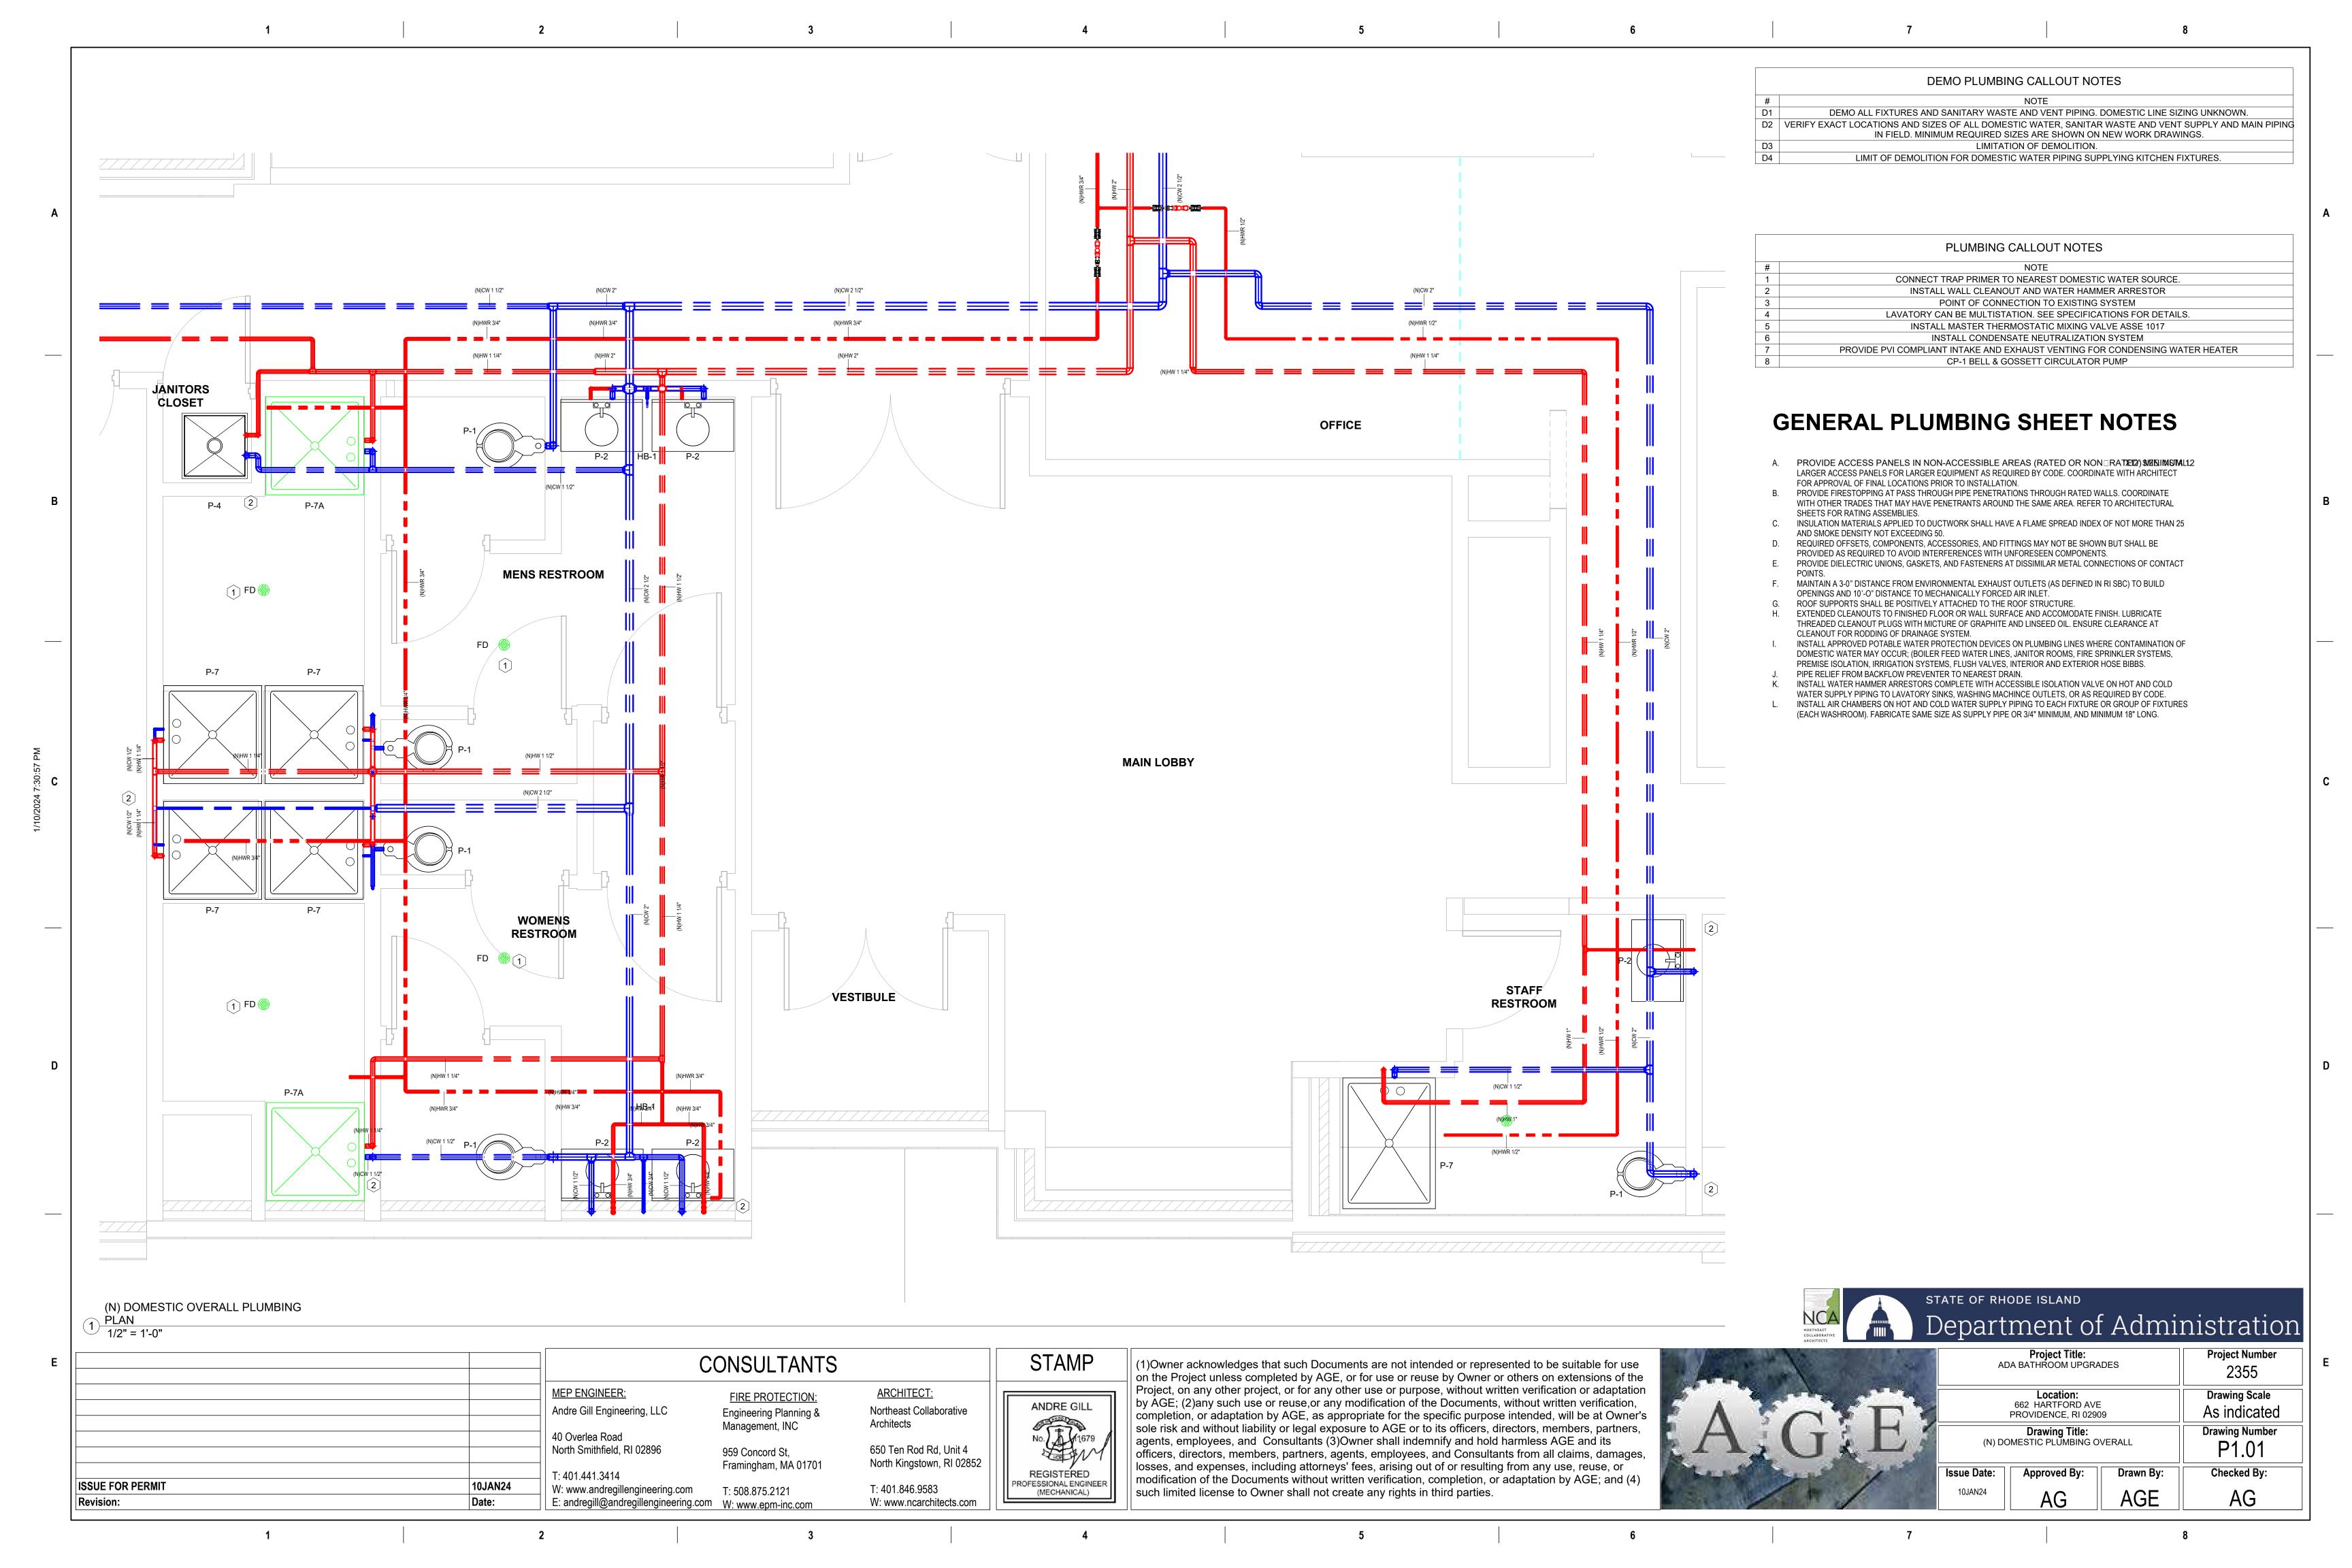
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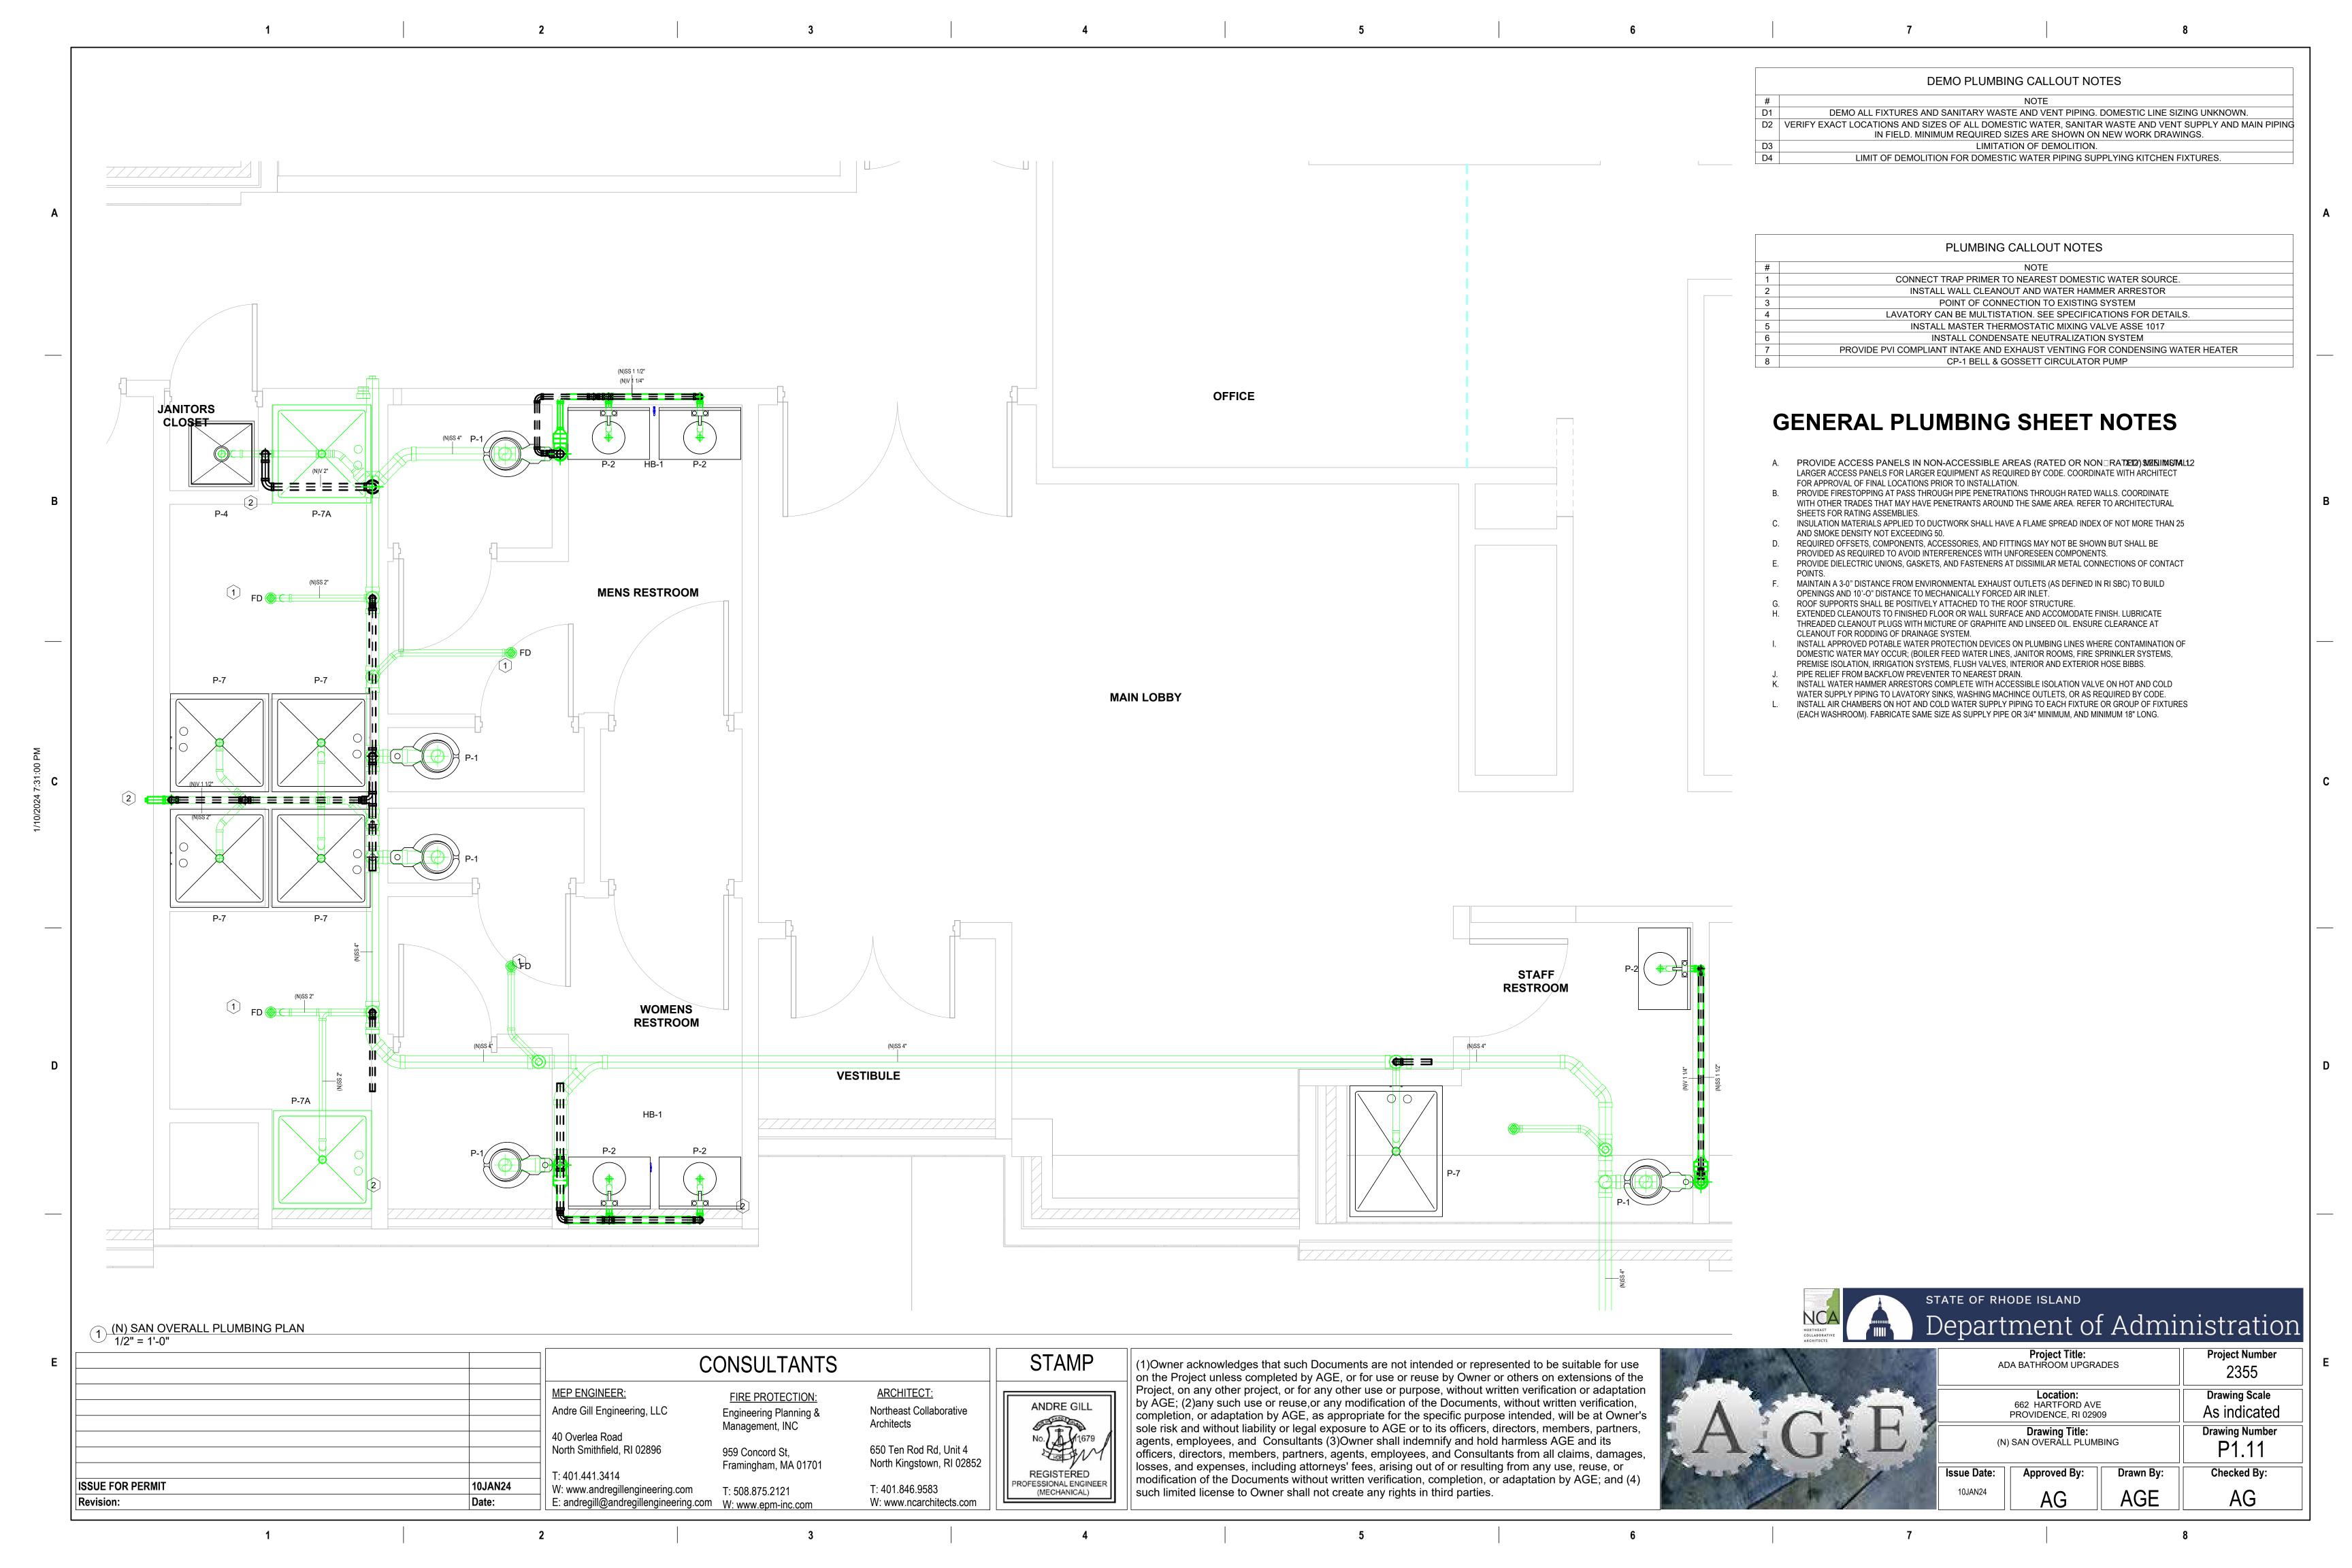
REGISTERED

PROFESSIONAL ENGINEER

(MECHANICAL)







(N)HWR 3/4" **D D**4 **JANITORS** CLOSET (D)HB-1 (D)P-2 ------1 FD (N)SS 2" MENS RESTROOM MENS RESTROOM **JANITORS** (N)CW 2 1/2" CLOSET (D)P-4 **WOMENS RESTROOM** 1 FD (N)SS 2" **WOMENS** (D)P-2 (D) BATHROOMS PLUMBING 1/2" = 1'-0"

DEMO PLUMBING CALLOUT NOTES DEMO ALL FIXTURES AND SANITARY WASTE AND VENT PIPING. DOMESTIC LINE SIZING UNKNOWN. D2 VERIFY EXACT LOCATIONS AND SIZES OF ALL DOMESTIC WATER, SANITAR WASTE AND VENT SUPPLY AND MAIN PIPING IN FIELD. MINIMUM REQUIRED SIZES ARE SHOWN ON NEW WORK DRAWINGS. LIMITATION OF DEMOLITION. LIMIT OF DEMOLITION FOR DOMESTIC WATER PIPING SUPPLYING KITCHEN FIXTURES.

	PLUMBING CALLOUT NOTES						
#	NOTE						
1	CONNECT TRAP PRIMER TO NEAREST DOMESTIC WATER SOURCE.						
2	INSTALL WALL CLEANOUT AND WATER HAMMER ARRESTOR						
3	POINT OF CONNECTION TO EXISTING SYSTEM						
4	LAVATORY CAN BE MULTISTATION. SEE SPECIFICATIONS FOR DETAILS.						
5	INSTALL MASTER THERMOSTATIC MIXING VALVE ASSE 1017						
6	INSTALL CONDENSATE NEUTRALIZATION SYSTEM						
7	PROVIDE PVI COMPLIANT INTAKE AND EXHAUST VENTING FOR CONDENSING WATER HEATER						
8	CP-1 BELL & GOSSETT CIRCULATOR PUMP						

GENERAL PLUMBING SHEET NOTES

- A. PROVIDE ACCESS PANELS IN NON-ACCESSIBLE AREAS (RATED OR NON□RATXETIZ') \$\textit{SUTINI IM SITAL L2} LARGER ACCESS PANELS FOR LARGER EQUIPMENT AS REQUIRED BY CODE. COORDINATE WITH ARCHITECT
- FOR APPROVAL OF FINAL LOCATIONS PRIOR TO INSTALLATION. B. PROVIDE FIRESTOPPING AT PASS THROUGH PIPE PENETRATIONS THROUGH RATED WALLS. COORDINATE
- WITH OTHER TRADES THAT MAY HAVE PENETRANTS AROUND THE SAME AREA. REFER TO ARCHITECTURAL
- SHEETS FOR RATING ASSEMBLIES.
- INSULATION MATERIALS APPLIED TO DUCTWORK SHALL HAVE A FLAME SPREAD INDEX OF NOT MORE THAN 25 AND SMOKE DENSITY NOT EXCEEDING 50.
- REQUIRED OFFSETS, COMPONENTS, ACCESSORIES, AND FITTINGS MAY NOT BE SHOWN BUT SHALL BE PROVIDED AS REQUIRED TO AVOID INTERFERENCES WITH UNFORESEEN COMPONENTS.
- PROVIDE DIELECTRIC UNIONS, GASKETS, AND FASTENERS AT DISSIMILAR METAL CONNECTIONS OF CONTACT
- MAINTAIN A 3-0" DISTANCE FROM ENVIRONMENTAL EXHAUST OUTLETS (AS DEFINED IN RI SBC) TO BUILD OPENINGS AND 10'-O" DISTANCE TO MECHANICALLY FORCED AIR INLET.
- ROOF SUPPORTS SHALL BE POSITIVELY ATTACHED TO THE ROOF STRUCTURE. EXTENDED CLEANOUTS TO FINISHED FLOOR OR WALL SURFACE AND ACCOMODATE FINISH. LUBRICATE
- THREADED CLEANOUT PLUGS WITH MICTURE OF GRAPHITE AND LINSEED OIL. ENSURE CLEARANCE AT CLEANOUT FOR RODDING OF DRAINAGE SYSTEM.
- I. INSTALL APPROVED POTABLE WATER PROTECTION DEVICES ON PLUMBING LINES WHERE CONTAMINATION OF DOMESTIC WATER MAY OCCUR; (BOILER FEED WATER LINES, JANITOR ROOMS, FIRE SPRINKLER SYSTEMS, PREMISE ISOLATION, IRRIGATION SYSTEMS, FLUSH VALVES, INTERIOR AND EXTERIOR HOSE BIBBS.
- PIPE RELIEF FROM BACKFLOW PREVENTER TO NEAREST DRAIN.
- INSTALL WATER HAMMER ARRESTORS COMPLETE WITH ACCESSIBLE ISOLATION VALVE ON HOT AND COLD
- WATER SUPPLY PIPING TO LAVATORY SINKS, WASHING MACHINCE OUTLETS, OR AS REQUIRED BY CODE. L. INSTALL AIR CHAMBERS ON HOT AND COLD WATER SUPPLY PIPING TO EACH FIXTURE OR GROUP OF FIXTURES

(EACH WASHROOM). FABRICATE SAME SIZE AS SUPPLY PIPE OR 3/4" MINIMUM, AND MINIMUM 18" LONG.

STATE OF RHODE ISLAND Department of Administration

	AD	Project Title: A BATHROOM UPGRA	Project Number 2355	
		Location: 662 HARTFORD AVE PROVIDENCE, RI 0290	Drawing Scale As indicated	
AUL	Drawing Title: MAIN BATHROOMS			Drawing Number P3.00
	Issue Date:	Approved By:	Drawn By:	Checked By:
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Andre Gill Engineering, LLC

North Smithfield, RI 02896

LIMITATION OF DEMOLITION. D4 LIMIT OF DEMOLITION FOR DOMESTIC WATER PIPING SUPPLYING KITCHEN FIXTURES. CP-1 BELL & GOSSETT CIRCULATOR PUMP **GENERAL PLUMBING SHEET NOTES** FOR APPROVAL OF FINAL LOCATIONS PRIOR TO INSTALLATION. WITH OTHER TRADES THAT MAY HAVE PENETRANTS AROUND THE SAME AREA. REFER TO ARCHITECTURAL SHEETS FOR RATING ASSEMBLIES. INSULATION MATERIALS APPLIED TO DUCTWORK SHALL HAVE A FLAME SPREAD INDEX OF NOT MORE THAN 25 AND SMOKE DENSITY NOT EXCEEDING 50. PROVIDED AS REQUIRED TO AVOID INTERFERENCES WITH UNFORESEEN COMPONENTS. OPENINGS AND 10'-O" DISTANCE TO MECHANICALLY FORCED AIR INLET. G. ROOF SUPPORTS SHALL BE POSITIVELY ATTACHED TO THE ROOF STRUCTURE. CLEANOUT FOR RODDING OF DRAINAGE SYSTEM. PREMISE ISOLATION, IRRIGATION SYSTEMS, FLUSH VALVES, INTERIOR AND EXTERIOR HOSE BIBBS. PIPE RELIEF FROM BACKFLOW PREVENTER TO NEAREST DRAIN. **HALLWAY** WATER SUPPLY PIPING TO LAVATORY SINKS, WASHING MACHINCE OUTLETS, OR AS REQUIRED BY CODE. L. INSTALL AIR CHAMBERS ON HOT AND COLD WATER SUPPLY PIPING TO EACH FIXTURE OR GROUP OF FIXTURES (EACH WASHROOM). FABRICATE SAME SIZE AS SUPPLY PIPE OR 3/4" MINIMUM, AND MINIMUM 18" LONG. **MAIN LOBBY** MAIN LOBBY RESTROOM OFFICE OFFICE (D)CO STAFF RESTROOM D1D2 RESTROOM **D3●** STATE OF RHODE ISLAND 2 (N) STAFF BATHROOM PLUMBING 3/4" = 1'-0" 1 (D) STAFF BATHROOM PLUMBING 3/4" = 1'-0" STAMP CONSULTANTS (1)Owner acknowledges that such Documents are not intended or represented to be suitable for use on the Project unless completed by AGE, or for use or reuse by Owner or others on extensions of the Project, on any other project, or for any other use or purpose, without written verification or adaptation ARCHITECT: MEP ENGINEER: FIRE PROTECTION: by AGE; (2)any such use or reuse,or any modification of the Documents, without written verification, completion, or adaptation by AGE, as appropriate for the specific purpose intended, will be at Owner's ANDRE GILL Andre Gill Engineering, LLC Northeast Collaborative Engineering Planning & Management, INC Architects sole risk and without liability or legal exposure to AGE or to its officers, directors, members, partners, 40 Overlea Road agents, employees, and Consultants (3)Owner shall indemnify and hold harmless AGE and its 650 Ten Rod Rd, Unit 4 North Smithfield, RI 02896 959 Concord St, officers, directors, members, partners, agents, employees, and Consultants from all claims, damages, North Kingstown, RI 02852 Framingham, MA 01701 losses, and expenses, including attorneys' fees, arising out of or resulting from any use, reuse, or REGISTERED modification of the Documents without written verification, completion, or adaptation by AGE; and (4) PROFESSIONAL ENGINEER **ISSUE FOR PERMIT** T: 401.846.9583 W: www.andregillengineering.com T: 508.875.2121 (MECHANICAL) such limited license to Owner shall not create any rights in third parties. E: andregill@andregillengineering.com W: www.epm-inc.com W: www.ncarchitects.com

DEMO PLUMBING CALLOUT NOTES DEMO ALL FIXTURES AND SANITARY WASTE AND VENT PIPING. DOMESTIC LINE SIZING UNKNOWN. D2 VERIFY EXACT LOCATIONS AND SIZES OF ALL DOMESTIC WATER, SANITAR WASTE AND VENT SUPPLY AND MAIN PIPING IN FIELD. MINIMUM REQUIRED SIZES ARE SHOWN ON NEW WORK DRAWINGS.

	PLUMBING CALLOUT NOTES						
#	NOTE						
1	CONNECT TRAP PRIMER TO NEAREST DOMESTIC WATER SOURCE.						
2	INSTALL WALL CLEANOUT AND WATER HAMMER ARRESTOR						
3	POINT OF CONNECTION TO EXISTING SYSTEM						
4	LAVATORY CAN BE MULTISTATION. SEE SPECIFICATIONS FOR DETAILS.						
5	INSTALL MASTER THERMOSTATIC MIXING VALVE ASSE 1017						
6	INSTALL CONDENSATE NEUTRALIZATION SYSTEM						
7	PROVIDE PVI COMPLIANT INTAKE AND EXHAUST VENTING FOR CONDENSING WATER HEATER						
0	CD 4 DELL & COSSETT CIDCUL ATOD DUMP						


- A. PROVIDE ACCESS PANELS IN NON-ACCESSIBLE AREAS (RATED OR NON□RATXETIZ') \$\textit{SUTINI IM SITAL L2} LARGER ACCESS PANELS FOR LARGER EQUIPMENT AS REQUIRED BY CODE. COORDINATE WITH ARCHITECT
- B. PROVIDE FIRESTOPPING AT PASS THROUGH PIPE PENETRATIONS THROUGH RATED WALLS. COORDINATE

- REQUIRED OFFSETS, COMPONENTS, ACCESSORIES, AND FITTINGS MAY NOT BE SHOWN BUT SHALL BE
- PROVIDE DIELECTRIC UNIONS, GASKETS, AND FASTENERS AT DISSIMILAR METAL CONNECTIONS OF CONTACT
- MAINTAIN A 3-0" DISTANCE FROM ENVIRONMENTAL EXHAUST OUTLETS (AS DEFINED IN RI SBC) TO BUILD

- H. EXTENDED CLEANOUTS TO FINISHED FLOOR OR WALL SURFACE AND ACCOMODATE FINISH. LUBRICATE THREADED CLEANOUT PLUGS WITH MICTURE OF GRAPHITE AND LINSEED OIL. ENSURE CLEARANCE AT
- I. INSTALL APPROVED POTABLE WATER PROTECTION DEVICES ON PLUMBING LINES WHERE CONTAMINATION OF DOMESTIC WATER MAY OCCUR; (BOILER FEED WATER LINES, JANITOR ROOMS, FIRE SPRINKLER SYSTEMS,
- INSTALL WATER HAMMER ARRESTORS COMPLETE WITH ACCESSIBLE ISOLATION VALVE ON HOT AND COLD

Department of Administration

	Project Title: ADA BATHROOM UPGRADES			Project Number 2355
		Location: 662 HARTFORD AVE PROVIDENCE, RI 029	Drawing Scale As indicated	
AUL	Drawing Title: STAFF BATHROOMS			Drawing Number P3.01
	Issue Date: Approved By: Drawn By:			Checked By:
The state of the s	10JAN24	AG	AGE	AG

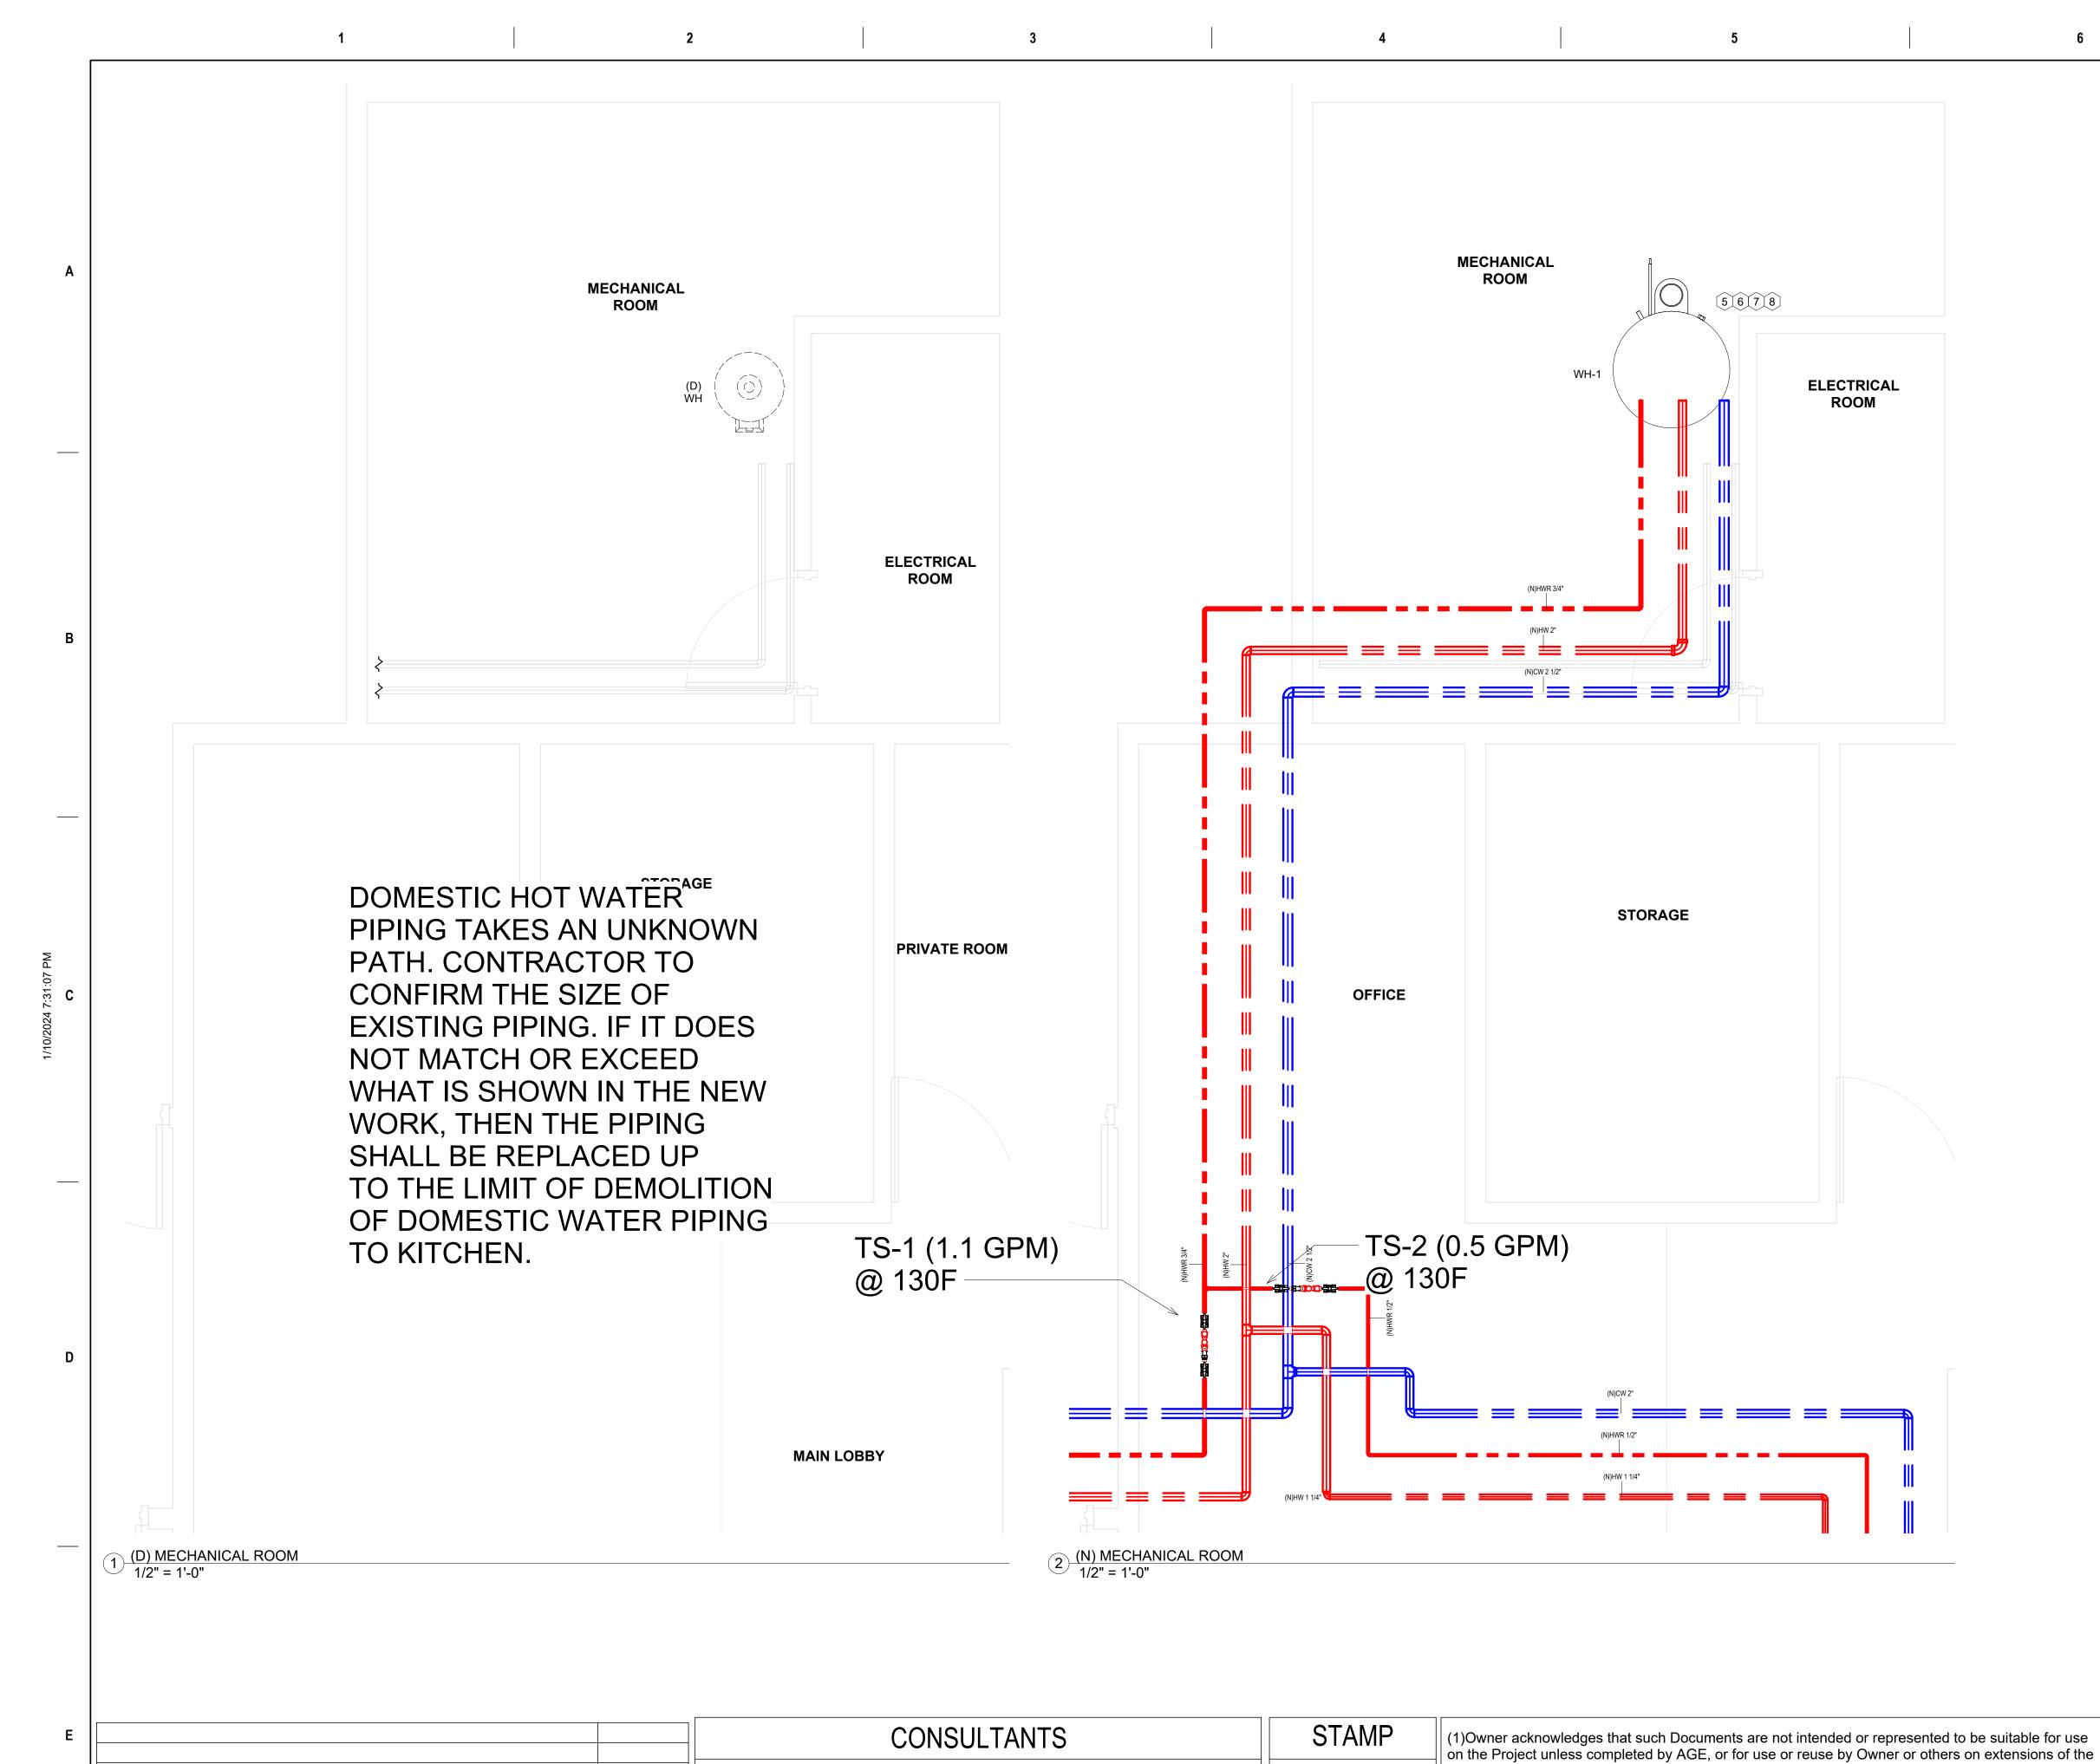

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3	POINT OF CONNECTION TO EXISTING SYSTEM						
4	LAVATORY CAN BE MULTISTATION. SEE SPECIFICATIONS FOR DETAILS.						
5	INSTALL MASTER THERMOSTATIC MIXING VALVE ASSE 1017						
6	INSTALL CONDENSATE NEUTRALIZATION SYSTEM						
7	PROVIDE PVI COMPLIANT INTAKE AND EXHAUST VENTING FOR CONDENSING WATER HEATER						
8	CP-1 BELL & GOSSETT CIRCULATOR PUMP						

GENERAL PLUMBING SHEET NOTES

- A. PROVIDE ACCESS PANELS IN NON-ACCESSIBLE AREAS (RATED OR NON RATXEID) \$\text{SVIIIINSTML}12 LARGER ACCESS PANELS FOR LARGER EQUIPMENT AS REQUIRED BY CODE. COORDINATE WITH ARCHITECT FOR APPROVAL OF FINAL LOCATIONS PRIOR TO INSTALLATION.
- PROVIDE FIRESTOPPING AT PASS THROUGH PIPE PENETRATIONS THROUGH RATED WALLS. COORDINATE WITH OTHER TRADES THAT MAY HAVE PENETRANTS AROUND THE SAME AREA. REFER TO ARCHITECTURAL
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STATE OF RHODE ISLAND Department of Administration

	AE	Project T DA BATHROOM
		Location 662 HARTFO PROVIDENCE
AGE		Drawing MECHANICA
The same of the sa	Issue Date:	Approved
	10JAN24	AG

ΑΓ	Project Title: DA BATHROOM UPGRA	Project Number 2355	
	Location: 662 HARTFORD AVE PROVIDENCE, RI 0290	Drawing Scale As indicated	
	Drawing Title: MECHANICAL ROOM	Drawing Number P3.02	
Issue Date:	Approved By:	Checked By:	
10JAN24	AG	AGE	AG

ANDRE GILL

REGISTERED

PROFESSIONAL ENGINEER

(MECHANICAL)

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Architects

Northeast Collaborative

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North Kingstown, RI 02852

W: www.ncarchitects.com

FIRE PROTECTION:

Engineering Planning &

Framingham, MA 01701

Management, INC

959 Concord St,

T: 508.875.2121

Project, on any other project, or for any other use or purpose, without written verification or adaptation

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losses, and expenses, including attorneys' fees, arising out of or resulting from any use, reuse, or

such limited license to Owner shall not create any rights in third parties.

PLUMB	PLUMBING FIX TURES SCHEDULE								
MARK	CWFU	SIZE	HWFU	SIZE	WFU	SIZE	VFU	SIZE	REMARK
KS	1		1		2	1 1/2"		1 1/4"	EXISTING TO REMAIN
LAV	1.5	0.5"	1.5	0.5"	1	1 1/4"		1 1/4"	
LAV	1.5	0.5"	1.5	0.5"	1	1 1/4"		1 1/4"	
LAV	1.5	0.5"	1.5	0.5"	1	1 1/4"		1 1/4"	
LAV	1.5	0.5"	1.5	0.5"	1	1 1/4"		1 1/4"	
LAV	1.5	0.5"	1.5	0.5"	1	1 1/4"		1 1/4"	
WC	10	1"			4	4"		2"	
WC	10	1"			4	4"		2"	
WC	10	1"			4	4"		2"	
WC	10	1"			4	4"		2"	
WC	10	1"			4	4"		2"	
SH	3	0.5"	3	0.5"	2	1 1/2"		1 1/4"	
SH	3	0.5"	3	0.5"	2	1 1/2"		1 1/4"	
SH	3	0.5"	3	0.5"	2	1 1/2"		1 1/4"	
SH	3	0.5"	3	0.5"	2	1 1/2"		1 1/4"	
SH	3	0.5"	3	0.5"	2	1 1/2"		1 1/4"	
SH	3	0.5"	3	0.5"	2	1 1/2"		1 1/4"	
SH	3	0.5"	3	0.5"	2	1 1/2"		1 1/4"	
DF	0.25	0.5"			0.5	1 1/4"		1 1/4"	
MS	2.25	0.5"	2.25	0.5"	2	1 1/2"		1 1/4"	
FD					2	2"		1 1/4"	
FD					2	2"		1 1/4"	
FD					2	2"		1 1/4"	
FD					2	2"		1 1/4"	
FD					2	2"		1 1/4"	
TOTAL	82		31.75		53.5		0		
GPM	65		17					3	

HOT WATER CALCULATION

ISSUE FOR PERMIT

Q= 500*GPM*DT	
GPM=	17
Delta T=	80
Q output btu	680,000

			PLUMBING LEG	END
ETR	DEMO	NEW	ABBREVIATION	DESCRIPTION
(E)P-1	(D)P-1	© P-1	P-1	NO BASIS OF DESIGN SELECTED. PLEASE SEE SPECIFICATIONS FOR FURTHER DETAILS
(E)P-1	(D)P-1	P-1	P-1A	NO BASIS OF DESIGN SELECTED. PLEASE SEE SPECIFICATIONS FOR FURTHER DETAILS
(E)P-2	(D)P-2	P-2	P-2	MANUAL OPERATED. NO BASIS OF DESIGN SELECTED. PLEASE SEE SPECIFICATIONS FOR FURTHER DETAILS.
(E)P-2A	(D)P-2A	P-2A	P-2A	LAVATORY BRADLEY VERGE WASH BASIN LVAD2
(E)P-3	(D)P-3	P-3	P-3	LAVATORY BRADLEY VERGE WASH BASIN LVAD3
(E)P-4	(D)P-4	P-4	P-4	NO BASIS OF DESIGN SELECTED. PLEASE SEE SPECIFICATIONS FOR FURTHER DETAILS
(E)P-5	(D)P-5	P-5	P-5	ELKAY EZH20 BOTTLE FILLING STATION & VERSATILE BI-LEVEL ADA VANDAL-RESISTANT COOLER FILTERED REFRIGERATED LIGHT GRAY MODEL LZSTL8WSVRLK
(E)P-6	(D)P-6	P-6	P-6	NO BASIS OF DESIGN SELECTED. PLEASE SEE SPECIFICATIONS FOR FURTHER DETAILS
(E)P-7	(D)P-7	P-7	P-7	SHOWER
(E)P-7A	(D)P-7A	P-7A	P-7A	SHOWER ADA
(E)P-8	(D)P-8	P-8	P-8	VARIOUS EXISTING TO REMAIN SINKS
⊚⊢ (E)P-9	౷́– (D)P-9	⊚ ⊢ P-9	P-9	EMERGENCY EYEWASH
(E)P-10	(D)P-10	@ P-10	P-10	EMERGENCY SHOWER
(E)FD	• (D)FD	∳ FD	FD	VARIOUS. OPTIONS BASED ON LOCATION. NO BASIS OF DESIGN SELECTED. PLEASE SEE SPECIFICATIONS FOR FURTHER DETAILS.
(E)CO	° (D)CO	° CO	СО	VARIOUS. OPTIONS BASED ON LOCATION. NO BASIS OF DESIGN SELECTED. PLEASE SEE SPECIFICATIONS FOR FURTHER DETAILS.
WCO	WCO	WCO	wco	VARIOUS. OPTIONS BASED ON LOCATION. NO BASIS OF DESIGN SELECTED. PLEASE SEE SPECIFICATIONS FOR FURTHER DETAILS.
(E)HY-1	∯ (D)HY-1	∯ HY-1	HY-1	HYDRANT OUTDOOR
(E)HB-1	∯ (D)HB-1	∯ HB-1	HB-1	HOSE BIBS INDOOR
	•		CTE/POC	CONNECT TO EXISTING OR POINT OF CONNECTION
	•		LOD	LIMIT OF DEMOLITION
	#		KEYNOTE	
	B		POR	POINT OF REMOVAL

			CONSULTANTS	
		MEP ENGINEER:	FIRE PROTECTION:	ARCHITECT:
		Andre Gill Engineering, LLC	Engineering Planning & Management, INC	Northeast Collaborative Architects
		40 Overlea Road	•	
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	STATE OF RHODE ISLAND Department of Administration				
	Project Title: ADA BATHROOM UPGRADES	Project Number 2355			
	Location: 662 HARTFORD AVE PROVIDENCE, RI 02909	Drawing Scale 1/8" = 1'-0"			
AUL	Drawing Title: PLUMBING SCHEDULE	Drawing Number P5.00			

Drawn By: AGE

Checked By: AG

- CONDENSATE NEUTRALIZATION SYSTEM (500-800 MBH) PN 150772
- FACTORY- AUTHORIZED STARTUP AIR FILTRATION BOX (PN 121850)

PV 8410 06-2016

ISSUE FOR PERMIT

PUMP SCH	PUMP SCHEDULE (CP-X, CWP-X, BP-X HWP-X)												
							MOTOR DATA						
							MIN				VOLT	PHAS	
Mark	MARK	MANUFACTURER	MODEL	SERVICE	GPM	HEAD PRESSURE (FT)	EFFICIENCY	BHP	HP	RPM	S	E	REMARKS
CP-1		BELL & GOSSETT	ECOCIRC 20/18 SERIES	POTABLE WATER	1.5	8							






Conventional




Concentric (roof or sidewall)

Piping Guideline for one Conquest® or Power VTX® Water Heater

Refer to installation manual for complete details.

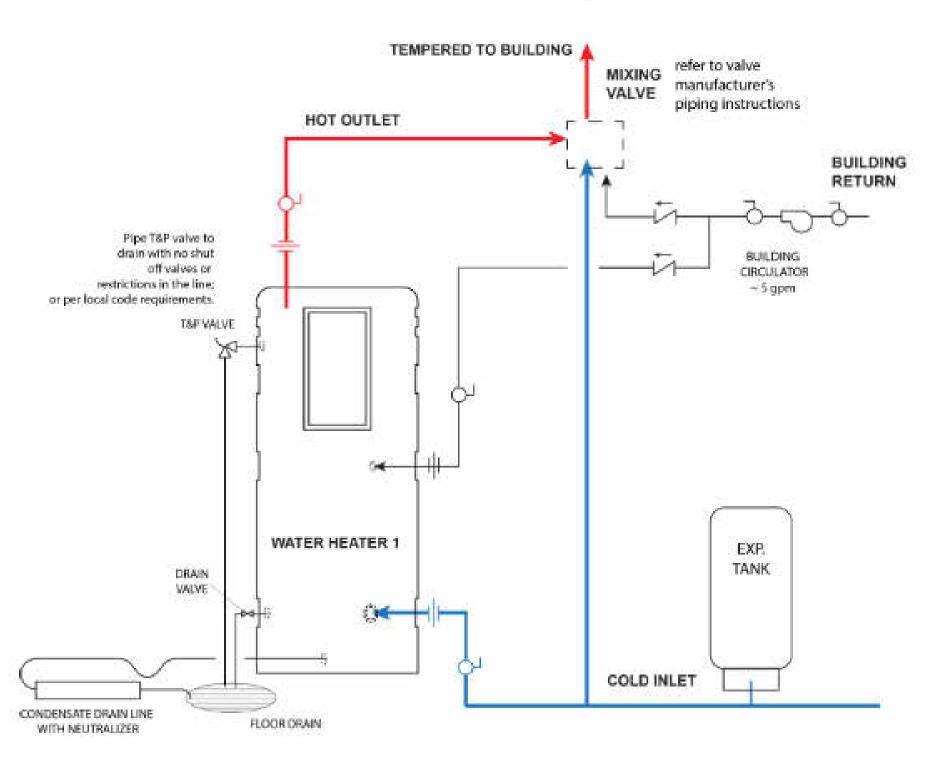

PVI Industries, LLC Engineered Water Heating Solutions* www.pvi.com Fort Worth, TX • 800-784-8326

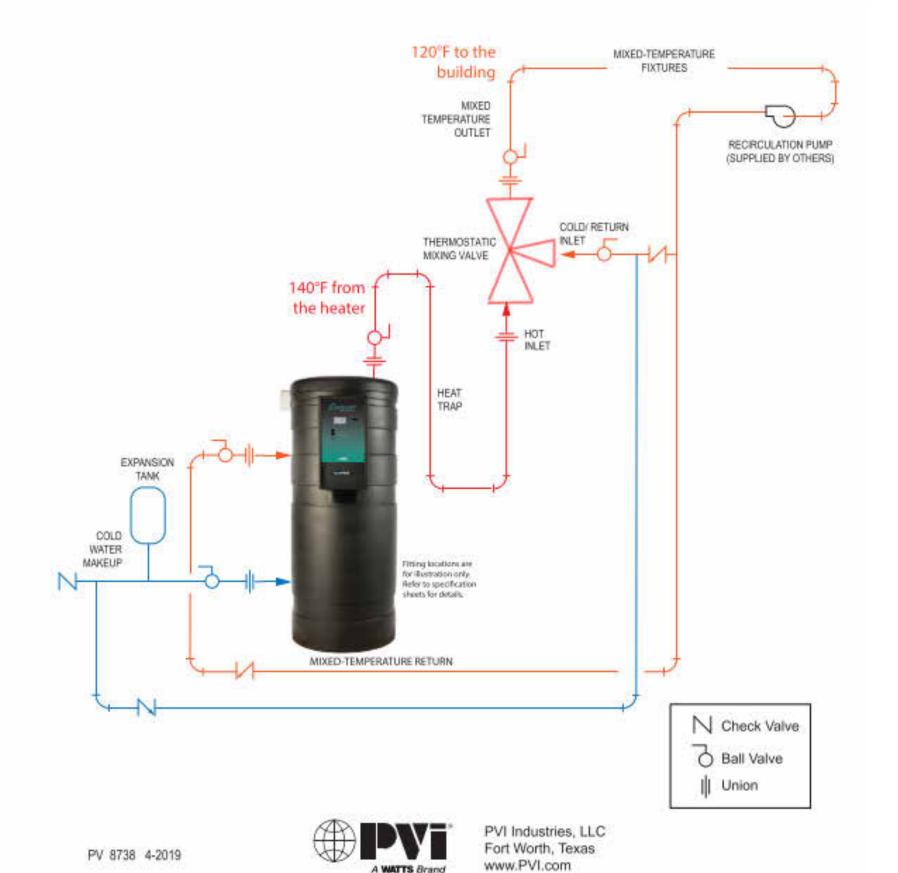



STATE OF RHODE ISLAND Department of Administration

ARCHITECTS	-
A G E	
	Issue
The second secon	10J

7		Location:				
		662 HARTFORD AVE	_			
9		PROVIDENCE, RI 0290	09			
	Drawing Title: PLUMBING SCHEDULE					
	Issue Date:	Approved By:	Drawn			
	10JAN24	AG	AG			

CONSULTANTS	

T: 508.875.2121

ARCHITECT: FIRE PROTECTION: Northeast Collaborative Engineering Planning & Architects Management, INC 650 Ten Rod Rd, Unit 4 959 Concord St, North Kingstown, RI 02852 Framingham, MA 01701

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P5.01 Checked By:

Project Number

2355

Drawing Scale

Drawing Number

W: www.ncarchitects.com